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TRUE NORTH CONSULTING GROUP IT AND COMMUNICATIONS 13284 POND SPRINGS RD., STE. 304 AUSTIN TX, 78729

CNG ENGINEERING MEP 1917 N. NEW BRAUNFELS AVE., SUITE 201,

W**GI** HYDROLOGY 5710 W HAUSMAN RD. SAN ANTONIO, TX 78249


SAN ANTONIO TX, 78208

BRACKENRIDGE PARK LAMBERT BEACH

A PROJECT OF THE CITY OF SAN ANTONIO 100 W. Houston Street San Antonio, Texas 78205

ANTIQUITIES AND ADVISORY BOARD MEETING SUBMITTAL 10 MARCH 2023



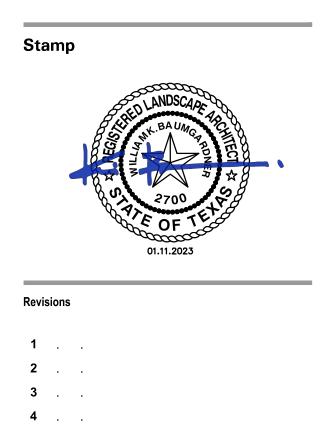

Date 10 MARCH 2023 Phase ISSUE FOR THC PERMIT: ADDENDUM 01 Job Number CNOS701 © 2020 SWA

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G0.01	SHEET INDEX
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C1.01	EXISTING CONDITIONS PLAN AT LAMBERT BEACH
C1.41	GRADING PLAN AT LAMBERT BEACH
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S4.04	PHOTO SURVEY & KEYNOTES
S4.05	PHOTO SURVEY AND KEYNOTES
S4.06	PHOTO SURVEY AND KEYNOTES

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Revisions

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Date 11 JANUARY 2023	
Phase	
95% CONSTRUCTION DOCUMENTS	
Job Number cnos701	
Scale	North
0 10' 20' 1" = 20'	
Drawing Title	
SHEET INDEX	



GENERAL NOTES:

- 1. FOR EXISTING UNDERGROUND UTILITIES REFER TO CIVIL ENGINEER'S PLAN.
- 2. VERIFY SITE INFORMATION, INCLUDING PROPERTY LINES, EASEMENTS, BUILDINGS, ROADWAY CURB AND GUTTERS, UTILITIES AND OTHER INFORMATION AFFECTING THE SCOPE OF WORK INCLUDED ON THESE DRAWINGS. MORE SPECIFIC UTILITY INFORMATION IS INDICATED ON THE CIVIL DRAWINGS.
- CONTRACTOR SHALL CONTACT THE OWNER AND THE LANDSCAPE 3. ARCHITECT FOR DIRECTION ON HOW TO PROCEED IF ACTUAL SITE CONDITIONS VARY FROM WHAT IS SHOWN ON THE DRAWINGS.
- 4. EXCAVATION IN THE VICINITY OF UTILITIES SHALL BE UNDERTAKEN WITH CARE. THE CONTRACTOR BEARS FULL RESPONSIBILITY FOR THIS WORK. THE CONTRACTOR SHALL VERIFY THE LOCATION OF ALL SITE UTILITIES PRIOR TO BEGINNING EXCAVATION. ANY DAMAGE TO UTILITIES THAT ARE TO REMAIN CAUSED BY ANY PERSON, VEHICLE, EQUIPMENT, OR TOOL RELATED TO THE EXECUTION OF THE CONTRACT SHALL BE REPAIRED IMMEDIATELY AT NO EXPENSE TO THE OWNER.
- BASE INFORMATION INCLUDING THE LOCATION OF PROPERTY LINES, EASEMENTS, BUILDINGS, ROADS AND CURBS HAVE BEEN TAKEN FROM THE CIVIL ENGINEER'S DRAWINGS. FOR ADDITIONAL INFORMATION REFER TO CIVIL ENGINEERING DRAWINGS.
- THE CONTRACTOR SHALL NOTIFY LOCAL AUTHORITIES AND THE GENERAL CONTRACTOR FOR LOCATION OF EXISTING UNDERGROUND UTILITIES. POT HOLE AS NECESSARY TO CONFIRM LOCATIONS PRIOR TO EXCAVATION.

PLANTING NOTES:

1. REFER TO L6 SERIES FOR PLANTING NOTES AND DETAILS

SITE/LANDSCAPE SLEEVING NOTES:

- 1. ALL SITE/LANDSCAPE SLEEVE LOCATIONS AND SIZES SHALL BE NOTED WITHIN THESE DOCUMENTS FOR FOUNTAIN AND DRAINAGE SCOPE OF WORK ONLY. ADDITIONAL MISCELLANEOUS FUTURE USE SLEEVES ARE PROVIDED IN SOME LOCATIONS. SLEEVES DO NOT INCLUDE SECURITY, ARCHITECTURAL, OR CIVIL OR SITE LIGHTING SCOPE.
- 2. CONTRACTOR IS RESPONSIBLE TO VERIFY ALL OTHER CONSULTANTS AND SUB-CONTRACTOR SLEEVING REQUIREMENTS AND PLACE SUCH SLEEVES PRIOR TO HARDSCAPE INSTALLATION.

GRADING AND EXCAVATION NOTES:

- IN ALL AREAS.
- - DISPOSED OF AWAY FROM THE JOB SITE.

 - STRUCTURE.
 - EXISTING TREES.
 - RADIAL TO THE TRUNK.

 - AND SLOPED AT 2% TO THE DOWNHILL SIDE.

 - ADJACENT TO PAVEMENTS.

1. ALL GRADING SHALL PROVIDE FOR NATURAL RUNOFF OF WATER WITHOUT LOW SPOTS OR POCKETS. FLOW LINES SHALL BE ACCURATELY SET AND SHALL NOT BE LESS THAN 0.5% GRADIENT UNLESS OTHERWISE NOTED. CONTRACTOR SHALL BE RESPONSIBLE FOR POSITIVE DRAINAGE

REFER TO THE GENERAL CONDITIONS AND THE TECHNICAL SPECIFICATIONS SECTIONS FOR THE PLACEMENT, COMPACTION, GRADING AND TESTING OF ALL FILL MATERIAL.

3. REFER TO CIVIL DOCUMENTS FOR ALL SITE EROSION CONTROL.

4. THE DEBRIS CREATED BY GRADING AND EXCAVATION OPERATIONS SHALL BECOME THE PROPERTY OF THE CONTRACTOR AND SHALL BE LEGALLY

CONTRACTORS SHALL TAKE CARE IN MINIMIZING THE DISTURBANCE TO THE EXISTING TREE TRUNKS AND ROOT SYSTEMS. ALL FINISH GRADING UNDER THE EXISTING TREES SHALL BE COMPLETED BY USING HAND TOOLS. NO LARGE EQUIPMENT OR ANY EQUIPMENT WITH TRACKS SHALL BE ALLOWED TO WORK OR DRIVE UNDER THE DRIP LINE OF THE EXISTING TREES, EXCEPT FOR THOSE AREAS WHERE PAVING IS TO BE PLACED.

6. CONTRACTOR SHALL TAKE CARE IN MINIMIZING THE DISTURBANCE TO SOIL WITHIN 15 FEET OF HISTORICAL STRUCTURES UNLESS EXPLICITLY DIRECTED TO DO SO BY THE DESIGN. ALL FINISHED GRADING IN AREAS WITHIN 15 FEET OF HISTORICAL STRUCTURES TO BE COMPLETED USING HAND TOOLS. NO LARGE EQUIPMENT OR ANY EQUIPMENT WITH TRACKS SHALL BE ALLOWED TO WORK OR DRIVE WITHIN 15 FEET OF THE

HAND EXCAVATE AND HAND COMPACT AREAS UNDER DRIPLINES OF

8. ALL EXCAVATION WITHIN THE DRIPLINES OF EXISTING TREES SHALL BE

9. REFER TO CIVIL DRAWINGS FOR CONNECTIONS TO DRAINS AND CONTINUATION TO DISCHARGE PIPING.

10. EXISTING UTILITY STRUCTURES AND LIDS ARE TO BE ADJUSTED TO MATCH PROPOSED FINISHED GRADE (UNLESS OTHERWISE NOTED).

11. AFTER PLACEMENT AND ADJUSTMENT OF DRAIN BODIES TO PROPOSED FINISH GRADES, CONTRACTOR SHALL NOTIFY LANDSCAPE ARCHITECT TO COORDINATE AND APPROVE FINAL GRADES IN ALL AREAS.

12. GRADING ON TRAILS TO BE CONSISTENT AND TO TRANSITION WITH EXISTING GRADES. TRAIL SECTION SHALL BE CROWNED IN FLAT AREAS

13. THE CONTRACTOR SHALL REQUEST A REVIEW FOR INSPECTION OF FINAL IN PLACE GRADING A MINIMUM OF 48 HOURS IN ADVANCE OF PERFORMING ANY WORK UNLESS OTHERWISE NOTED ON THIS SHEET. FINAL GRADING SHALL BE APPROVED BY THE LANDSCAPE ARCHITECT IN THE FIELD AND PRIOR TO SURFACE CONSTRUCTION AND PLANTING. CONTRACTOR IS RESPONSIBLE FOR POSITIVE FLOW OF DRAINAGE.

14. REFER TO PLANTING NOTES FOR GRADING REQUIREMENTS FOR AREAS

LAYOUT/DIMENSIONAL CONTROL NOTES:

- 1. THE CONTRACTOR SHALL LAYOUT AND VERIFY ALL DIMENSIONS PRIOR TO CONSTRUCTION. ANY DISCREPANCIES SHALL BE BROUGHT TO THE ATTENTION OF THE LANDSCAPE ARCHITECT FOR DIRECTION AND RESOLUTION OF DISCREPANCIES PRIOR TO PROCEEDING.
- 2. FOR DIMENSIONS OF BUILDING, PARKING STRUCTURE AND OTHER RELATED NON-LANDSCAPE WORK, REFER TO THE ARCHITECTURAL OR CIVIL DRAWINGS.
- 3. VERIFY LOCATIONS OF ALL SITE IMPROVEMENTS INSTALLED UNDER OTHER SECTIONS. IF ANY PART OF THIS PLAN CANNOT BE FOLLOWED DUE TO SITE CONDITIONS, CONTACT THE LANDSCAPE ARCHITECT FOR INSTRUCTION PRIOR TO COMMENCING WORK.
- 4. ALL DIMENSIONS ARE TAKEN PERPENDICULAR TO WALL, CURB, P.O.B., OR CENTERLINE UNLESS OTHERWISE NOTED.
- EDGES OF IRREGULAR PAVING ARE LOCATED BY COORDINATES AND ARE GENERAL LOCATIONS. CONTRACTOR SHALL STAKE POINTS IN FIELD. STAKED EDGES SHALL BE REVIEWED BY LANDSCAPE ARCHITECT FOR FINAL LAYOUT APPROVAL AND SETTING AND MAY REQUIRE ADJUSTMENTS IN FIELD FOR FINAL PLACEMENT. WRITTEN DIMENSIONS TAKE PRECEDENCE OVER SCALED DIMENSIONS.
- FOR HANDICAPPED STANDARDS, VERIFY COMPLIANCE WITH LATEST EDITION OF ADA AND LOCAL AND STATE HANDICAP STANDARDS PRIOR TO CONSTRUCTION. WHERE FIELD MODIFICATIONS ARE REQUIRED FOR COMPLIANCE, CONSTRUCTION CHANGES MAY BE APPLIED INCLUDING DIFFERENT GRADES AND LAYOUT THAN THOSE NOTED HEREIN.
- 7. SURFACES SHALL BE ADA COMPLIANT ALONG ACCESS AND EGRESS FLAGSTONE SHALL HAVE NO ADJACENT SURFACE IRREGULARITIES GREATER THAN 1/4" IN ANY PIECE OR BETWEEN ADJACENT PIECES
- WHERE DIMENSIONS ARE CALLED AS "EQUAL", ALL REFERENCED ITEMS SHALL BE SPACED EQUALLY, MEASURED TO THEIR CENTER LINES OR OTHER NOTED REFERENCES.
- 9. INSTALL ALL INTERSECTING ELEMENTS AT 90 DEGREES TO EACH OTHER UNLESS OTHERWISE NOTED.

EXPANSION JOINT NOTES:

PROVIDE EXPANSION JOINTS IN ALL CASES WHERE CONCRETE FLATWORK MEETS VERTICAL STRUCTURES SUCH AS WALLS, CURBS, STEPS AND BUILDING OR WHERE CONCRETE ABUTS UTILITY VAULTS OR BOXES. REQUIRED EXPANSION JOINTS AT ALL VAULTS AND VERTICAL STRUCTURES MAY NOT BE SHOWN ON THESE DRAWINGS BUT ARE A CONSTRUCTION REQUIREMENT.

VICINITY MAP:



APPROX

ADJ BC BLDG BR BS BOC BW CJ CMU COH CONC CONT CL CLR CRS DIA DWG GALV

ABBREVIATIONS:

ABBREVIATIONS (CONT'D):

EJ

EΡ

EQ

FF

FL

FTG

FG

FOC

FIN

G

ΗT

HP

INT

IF

IP

LOW

MAX

MIN

NIC

OC

OPP

PERF

POB

PROP

PVMT

PT

RF

REF

REINF

REQ

ROW

SCH

SSEJ

SEC

SF

SHT

SIM

SQ

STL

SS

SWE

TAN

THK

TOB

TOS

TP

TR

ΤS

ΤY

TYP

UTL

WI

TC

SQFT

PA

PL

ESMT

EXIST

ELEV

EXPANSION JOINT ELEVATION EDGE OF PAVEMENT EQUAL EASEMENT EXISTING **FINISHED FLOOR FLOWLINE** FOOTING **FINISHED GRADE** FACE OF CURB FINISH **GUTTER** HEIGHT **HIGH POINT** INTERIOR LINEAR FEET LOW POINT LIMIT OF WORK MAXIMUM MINIMUM NOT IN CONTRACT **ON CENTER** OPPOSITE PLANTING AREA PERPENDICULAR PROPERTY LINE POINT OF BEGINNING PROPOSED PAVEMENT POINT RADIUS **REFER TO** REFERENCE REINFORCED REQUIRED **RIGHT OF WAY** SCHEDULE SUB-SURFACE EXPANSION JOINT SECTION SQUARE FEET SHEET SIMILAR SQUARE SQUARE FEET STEEL STAINLESS STEEL STATIC WATER ELEVATION TANGENT TOP OF CURB THICK / THICKNESS TOP OF BANK TOE OF SLOPE TOP OF PAVEMENT TOP OF RAMP TOP OF STEP TOP OF WALL TYPE TYPICAL UTILITY WATER LEVEL



ALIGN

ALIGN

EJ

CJ

X LX.XX

LX.XX

/----\XX

∠— R5'–0"

LX.XX/

EXPANSION JOINT

CONTROL OR CONSTRUCTION JOINTS RADIUS

PLAN ENLARGEMENT REFERENCE

ELEVATION REFERENCE

SECTION REFERENCE

DETAIL REFERENCE

SCHEDULE REFERENCE

— SITE: BRACKENRIDGE PARK, SAN ANTONIO, TX APPROXIMATE LIMIT OF WORK LINE IN LAYOUT

BRACKENRIDGE PARK

SAN ANTONIO, TX

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Date 11 JANUARY 2023 Phase 95% CONSTRUCTION DOCUMENTS Job Number

Scale

CNOS701

Drawing Title

GENERAL CONSTRUCTION NOTES








EXISTING UTILITY NOTES:

THAT ARE IN THE PROJECT AREA.

1.	THIS UTILITY PLAN HAS BEEN PREPARED TO THE BEST OF C EXISTING UTILITY INFORMATION. EXISTING UTILITY DATA SH FROM A SURVEY OF THE VISIBLE FEATURES AT THE SITE AN FROM THE UTILITIES.	OWN ON THIS LAYOUT WAS OBTAINED
2. IT IS ESSENTIAL THAT 48 HOURS PRIOR TO CONSTRUCTION ALL UTILITY COMPANIES BE NOT TO LOCATE AND TAG THEIR UNDERGROUND FACILITIES PRIOR TO EXCAVATION.		
	San Antonio Water System (Water, Sewer & Recycle Water) COSA Drainage City Sidewalk and Trenching Division COSA Traffic Signal Operations Texas State Wide One Call Locator CPS Energy AT&T Time warner	(210) 233-2011 (210) 207-2800 (210) 821-3240 (210) 207-7765 (800) 545-6005 (800) 545-6005 (800) 545-6005 (800) 545-6005
3.	3. THE CONTRACTOR NEEDS TO ALLOW FOR THE POSSIBILITY OF UNDETECTED UNDERGROUND UTILITIES. ALSO, THE CONTRACTOR MUST ALLOW FOR CHANGES DUE TO UTILITIES BEING IN LOCATIONS DIFFERENT FROM THOSE SHOWN ON THE UTILITY RECORD DRAWINGS. THE CONTRACTOR IS RESPONSIBLE FOR LOCATING AND EXPOSING CONFLICTS PRIOR TO CONSTRUCTION.	
4.	LOCATION AND DEPTH OF EXISTING UTILITIES SHOWN HERE LOCATIONS AND DEPTHS MUST BE VERIFIED BY THE CONTR AND THE CONTRACTOR SHALL BE RESPONSIBLE FOR THE F CONSTRUCTION. ANY DAMAGE TO EXISTING UTILITIES, WHE SHALL BE REPAIRED BY THE CONTRACTOR AT HIS EXPENSE	RACTOR PRIOR TO THE CONSTRUCTION PROTECTION OF SAME DURING THER SHOWN ON THE PLANS OR NOT,
5.	THE CONTRACTOR SHALL BE RESPONSIBLE FOR ACQUIRING AND ACCEPTANCES REQUIRED TO COMPLETE CONSTRUCT	
6.	DUE TO FEDERAL REGULATIONS TITLE 49, PART 192.181, CP	S MUST MAINTAIN ACCESS TO GAS

VALVES AT ALL TIMES. THE CONTRACTOR MUST PROTECT AND WORK AROUND ANY GAS VALVES

BY AN ON THE GROUND SURVEY OF VISIBLE SURFACE FEATURES. EXISTING IMPROVEMENTS WITH VISIBLE AND ACCESSIBLE UTILITY INFORMATION ARE SHOWN ON THE DRAWING. THE SURVEY ALSO INCLUDES INFORMATION BASED ON RECORD DOCUMENTS, OWNER PROVIDED INFO, AND PARTIALLY FROM SUBSURFACE UTILITY INVESTIGATIONS. UNDERGROUND UTILITIES SHOWN ARE FROM BEST AVAILABLE INFORMATION AT THE TIME OF DESIGN.

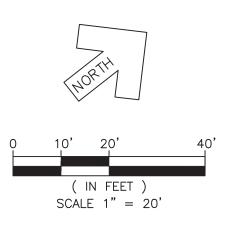

LEGEND

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EXISTING	PROPERTY LINE
EXISTING	CHAIN LINK FENCE
EXISTING	METAL FENCE
EXISTING	WOOD FENCE
EXISTING	WATER LINE
EXISTING	SANITARY SEWER LINE
EXISTING	STORM DRAIN LINE
EXISTING	GAS LINE
EXISTING	UGE (UNDERGROUND ELECTRIC) LINE
EXISTING	OHEC (OVERHEAD ELEC/COMM) LINE
EXISTING	OHE (OVERHEAD ELECTRIC) LINE
EXISTING	UTILITY POLE
EXISTING	GUY WIRE
EXISTING	COMMUNICATIONS MANHOLE
EXISTING	TELEPHONE MANHOLE
EXISTING	ELECTRIC MANHOLE
EXISTING	MANHOLE
EXISTING	STORM DRAIN MANHOLE
EXISTING	GRATE INLET
EXISTING	SANITARY SEWER MANHOLE
EXISTING	SANITARY CLEANOUT
EXISTING	FIRE HYDRANT
EXISTING	FIRE DEPARTMENT CONNECTION
EXISTING	POST INDICATOR VALVE
EXISTING	WATER VALVE
EXISTING	WATER METER
EXISTING	HOSE BIB
EXISTING	IRRIGATION VALVE
EXISTING	DOWNSPOUT
EXISTING	GAS VALVE
EXISTING	GAS METER
EXISTING	ELECTRICAL BOX
EXISTING	ELECTRIC METER
EXISTING	ELECTRICAL OUTLET
EXISTING	COMMUNICATIONS BOX
EXISTING	AIR CONDITIONING UNIT
EXISTING	GROUND LIGHT
EXISTING	LIGHT POLE
EXISTING	SIGN
EXISTING	VERTICAL PIPE
EXISTING	BOLLARD
EXISTING	CONTROL MARK
IRON ROE	D FOUND (IRF)
EXISTING	TREE
EXISTING	CONCRETE FLATWORK
EXISTING	CONCRETE
EXISTING	PAVERS
EXISTING	ASPHALT PAVEMENT
EXISTING	BUILDING OUTLINE
EXISTING	ACCESSIBLE PAVEMENT MARKING
EXISTING	RETAINING WALL

PROJECT CONTROL POINTS				
CP#	DESCRIPTION	NORTHING	EASTING	ELEVATION
CP2	IR W/ ORANGE VICKERY CAP	13718664.31	2137416.11	669.52
CP3	IR W/ ORANGE VICKERY CAP	13718763.44	2137676.81	667.06
CP20	+ ON CONCRETE	13718784.33	2137590.48	667.99
CP21	IR W/ PINK IES CAP	13718878.88	2137707.49	678.46
CP26	IR W/ RED CAP	13718917.28	2137393.23	675.05
CP1118	STAMPED COSA CAP	13718923.90	2137667.26	677.91





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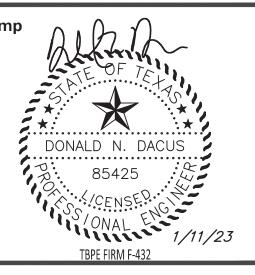
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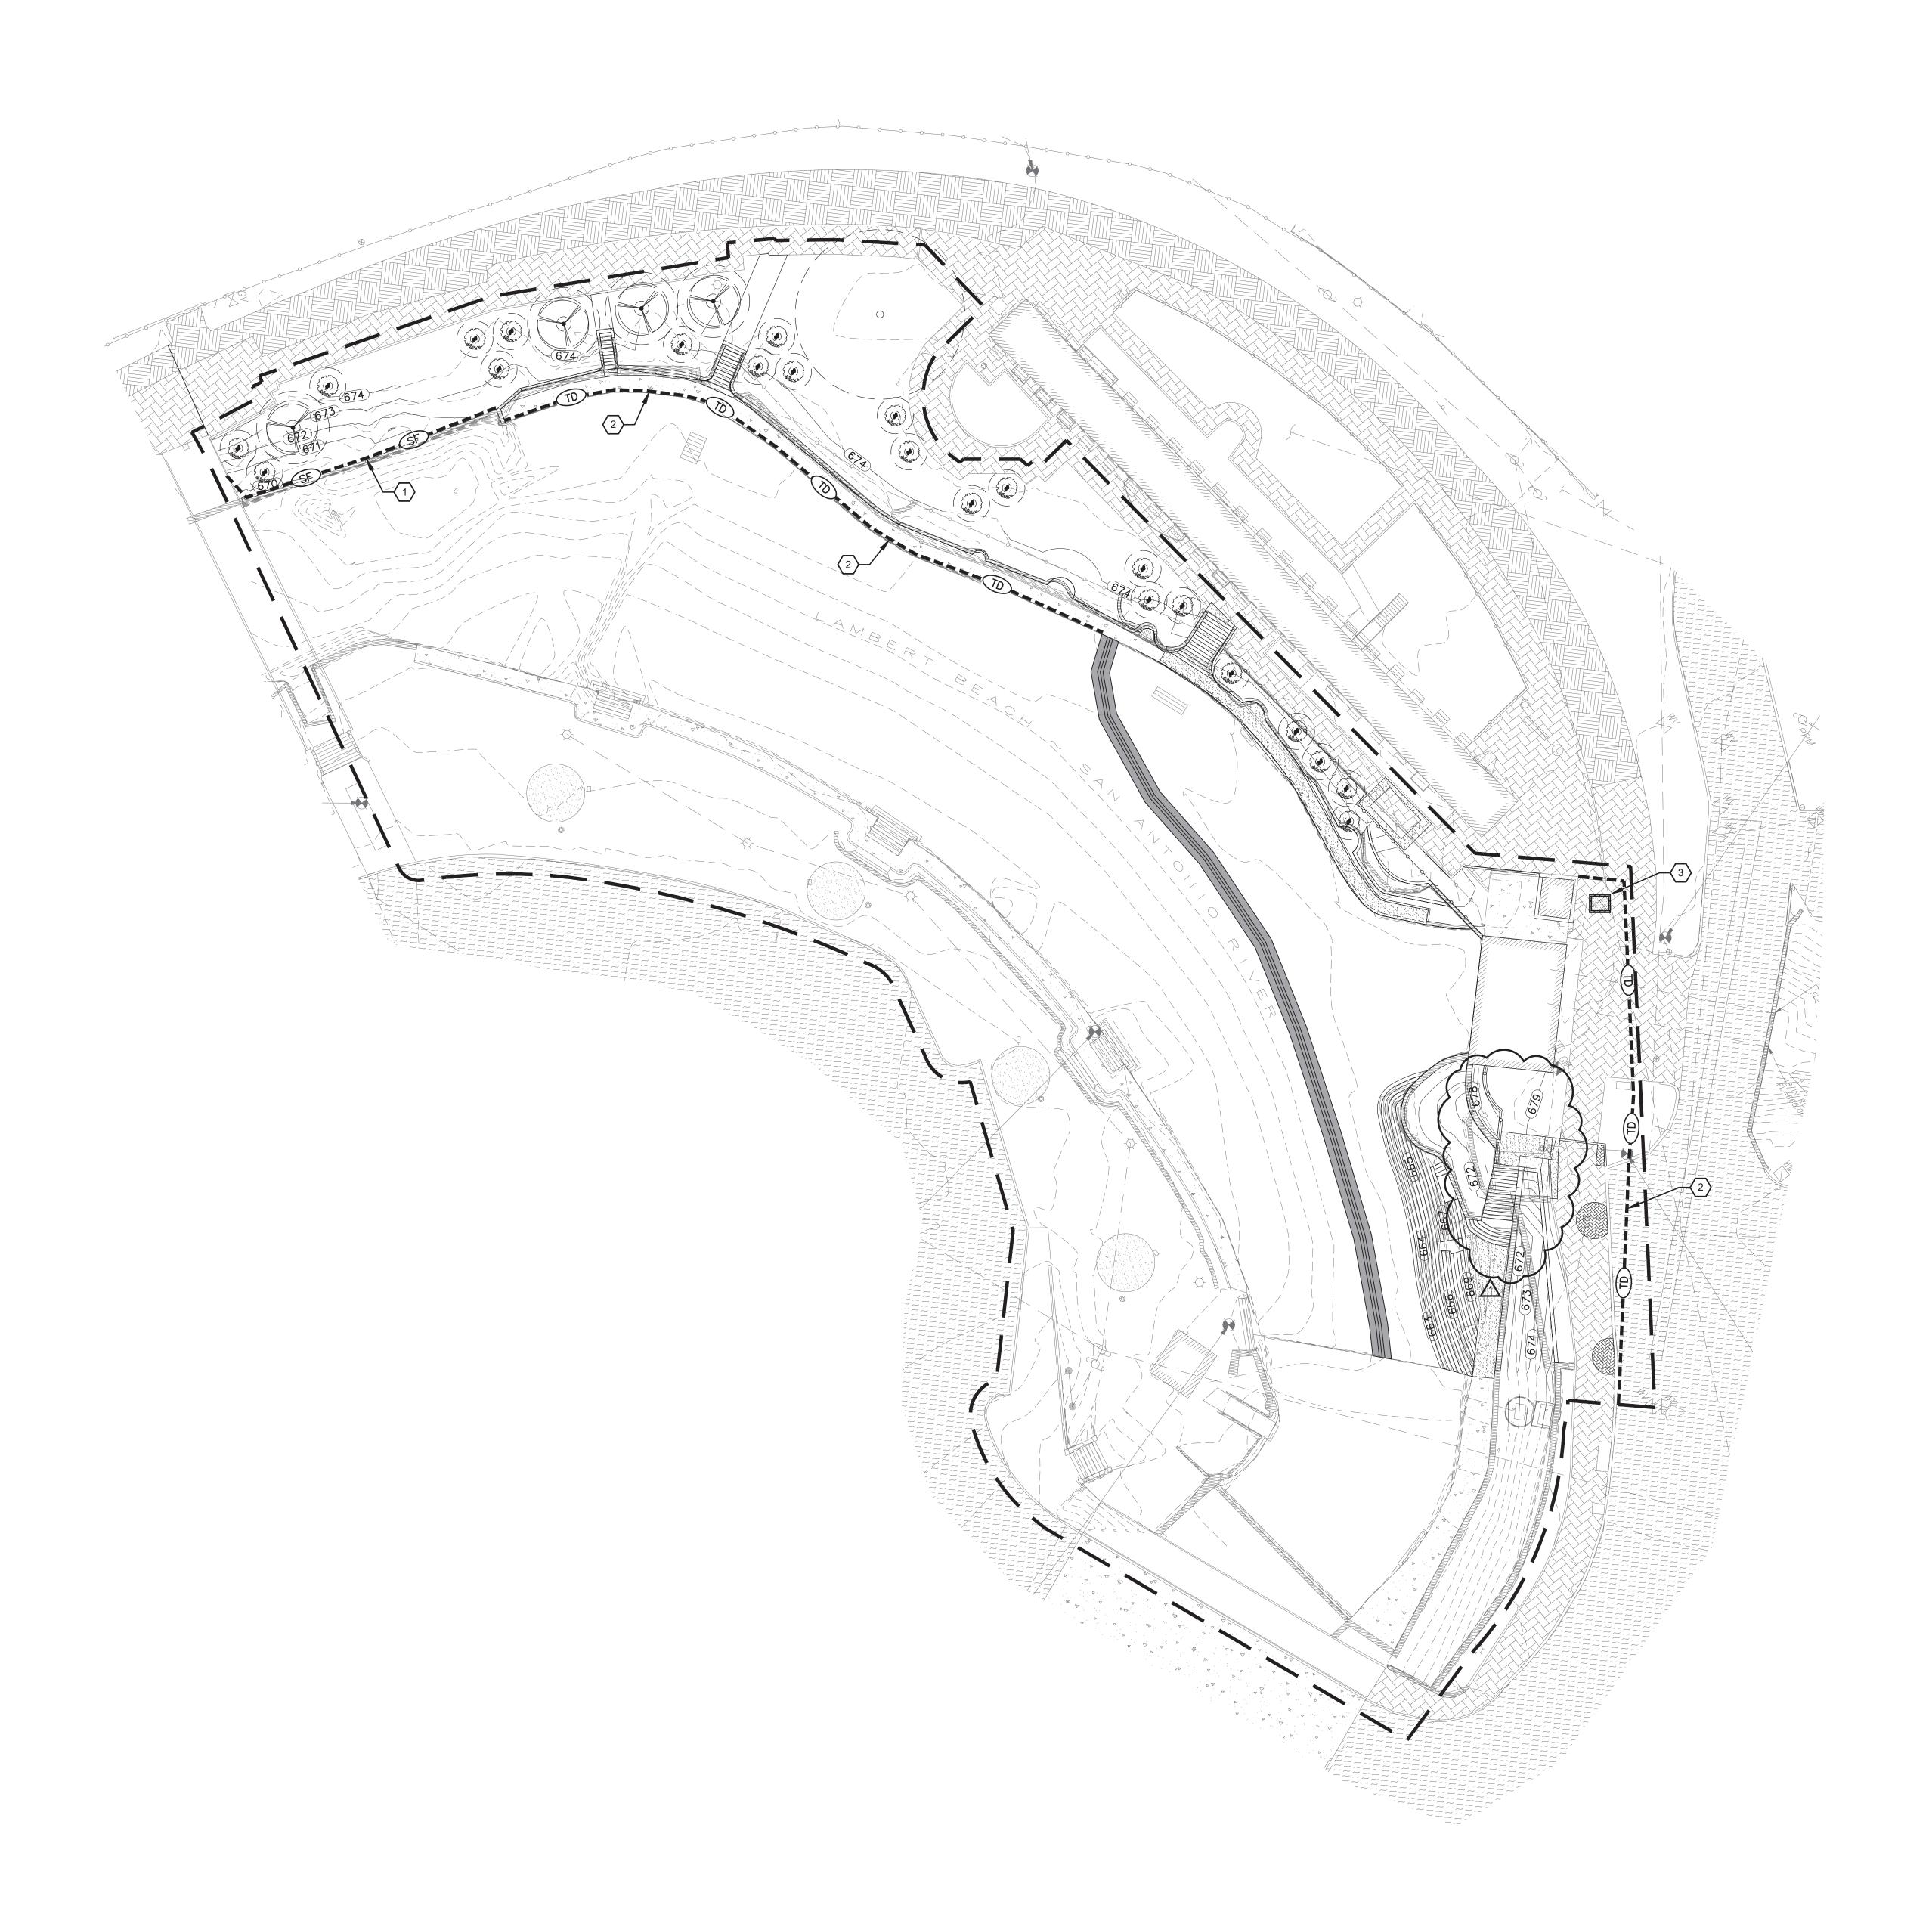
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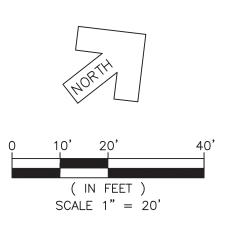
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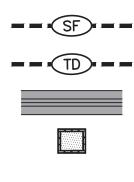
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Date 11 JANUARY 2023	
Phase 95% CONSTRUCTION DO Job Number CNOS701	CUMENTS
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Drawing Title	
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Drawing Number	
$\mathbf{C1}$	N1





LEGEND



TEMPORARY TRIANGLE DIKE TEMPORARY RIVER DIVERSION BERM TEMPORARY CONCRETE WASHOUT PIT

KEYNOTES

TEMPORARY SILT FENCE, SEE DETAIL 1/C5.10 2 TEMPORARY TRIANGLE DIKE, SEE DETAIL 2/C5.10 $\sqrt{3}$ concrete washout pit, see detail 3/c5.10

SHEET NOTES:

- 1. REFER TO SHEET C1.01 EXISTING CONDITIONS PLAN at LAMBERT BEACH FOR NOTES & LEGEND 2. REFER TO SHEET C1.11 EROSION &
- SEDIMENT CONTROL NOTES & DETAILS



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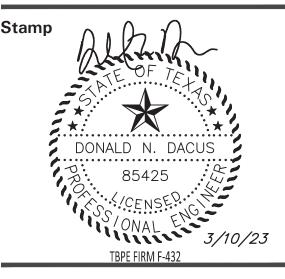
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Revisions


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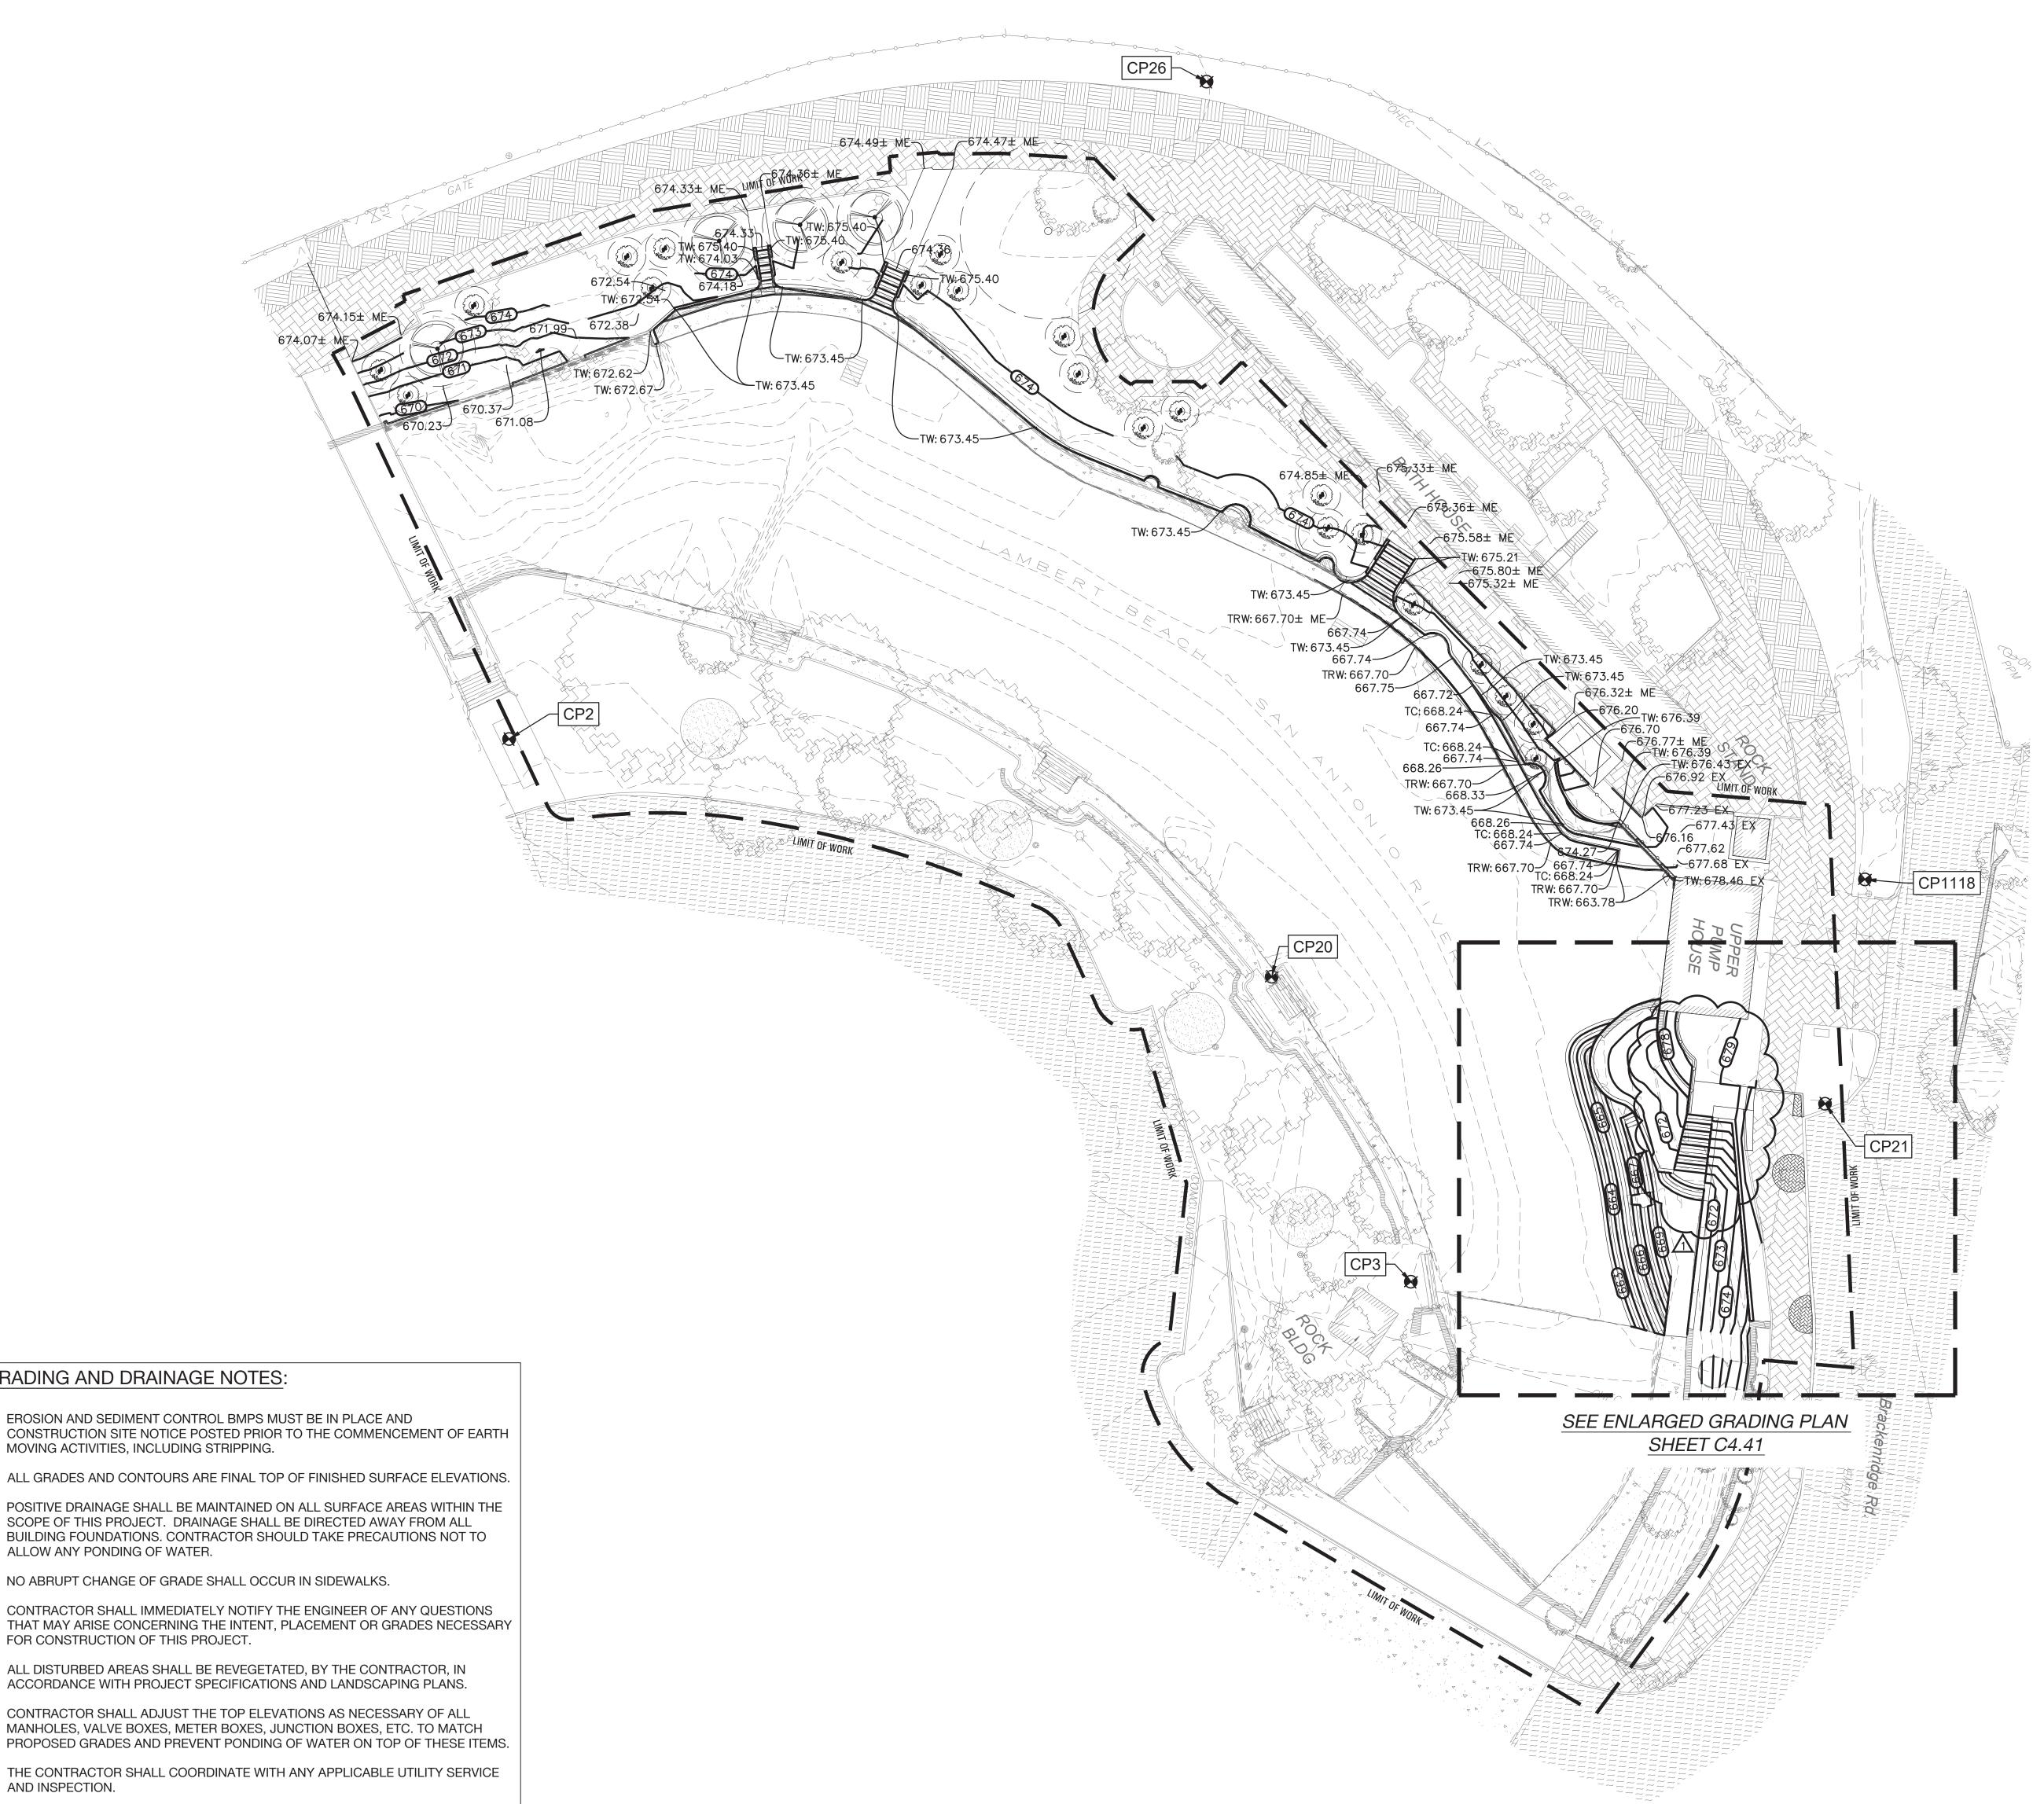
Date 11 JANUARY 2023 Phase 95% CONSTRUCTION DOCUMENTS Job Number CNOS701



North



C1.11

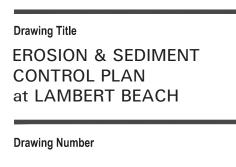

GRADING AND DRAINAGE NOTES:

- EROSION AND SEDIMENT CONTROL BMPS MUST BE IN PLACE AND CONSTRUCTION SITE NOTICE POSTED PRIOR TO THE COMMENCEMENT OF EARTH MOVING ACTIVITIES, INCLUDING STRIPPING.
- 2. ALL GRADES AND CONTOURS ARE FINAL TOP OF FINISHED SURFACE ELEVATIONS.
- . POSITIVE DRAINAGE SHALL BE MAINTAINED ON ALL SURFACE AREAS WITHIN THE SCOPE OF THIS PROJECT. DRAINAGE SHALL BE DIRECTED AWAY FROM ALL BUILDING FOUNDATIONS. CONTRACTOR SHOULD TAKE PRECAUTIONS NOT TO ALLOW ANY PONDING OF WATER.
- 4. NO ABRUPT CHANGE OF GRADE SHALL OCCUR IN SIDEWALKS.
- . CONTRACTOR SHALL IMMEDIATELY NOTIFY THE ENGINEER OF ANY QUESTIONS THAT MAY ARISE CONCERNING THE INTENT, PLACEMENT OR GRADES NECESSARY FOR CONSTRUCTION OF THIS PROJECT.
- 6. ALL DISTURBED AREAS SHALL BE REVEGETATED, BY THE CONTRACTOR, IN ACCORDANCE WITH PROJECT SPECIFICATIONS AND LANDSCAPING PLANS.
- CONTRACTOR SHALL ADJUST THE TOP ELEVATIONS AS NECESSARY OF ALL MANHOLES, VALVE BOXES, METER BOXES, JUNCTION BOXES, ETC. TO MATCH
- 8. THE CONTRACTOR SHALL COORDINATE WITH ANY APPLICABLE UTILITY SERVICE AND INSPECTION.
- 9. CONTRACTOR SHALL BE RESPONSIBLE FOR DEWATERING.
- 10. CONTRACTOR SHALL BE RESPONSIBLE FOR REMOVING ALL EXCAVATION AND/OR DEMOLITION MATERIALS FROM THE SITE.
- 11. THE CONTRACTOR SHALL BE RESPONSIBLE FOR FURNISHING AND MAINTAINING ALL SIGNS, BARRICADES, AND LIGHTING OR WARNING DEVICE(S) USED/REQUIRED WITH THIS WORK.

(IN FEET) SCALE 1" = 20'

LEGEND

— 675 —
———————————————————————————————————————
791.38
791.38± ME
532.24 EX
TC: 532.74
TW: 532.24
TRW: 532.24

NEW CONTOUR EXISTING CONTOUR NEW SPOT ELEVATION MATCH EXISTING SPOT ELEVATION EXISTING SPOT ELEVATION NEW TOP OF CURB ELEVATION NEW TOP OF WALL ELEVATION NEW TOP OF RIVER WALL ELEVATION

SHEET NOTES:

1. REFER TO SHEET C1.01 EXISTING CONDITIONS PLAN at LAMBERT BEACH FOR NOTES & LEGEND



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SAN ANTONIO, TX

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WORK5HOP CONSTRUCTION OBSERVATION 203 E. JONES AVE., SUITE 104 SAN ANTONIO, TX 78215

LUNDY & FRANKE ENGINEERING STRUCTURAL ENGINEER 549 HEIMER SAN ANTONIO, TX 78232


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CNG ENGINEERING MEP

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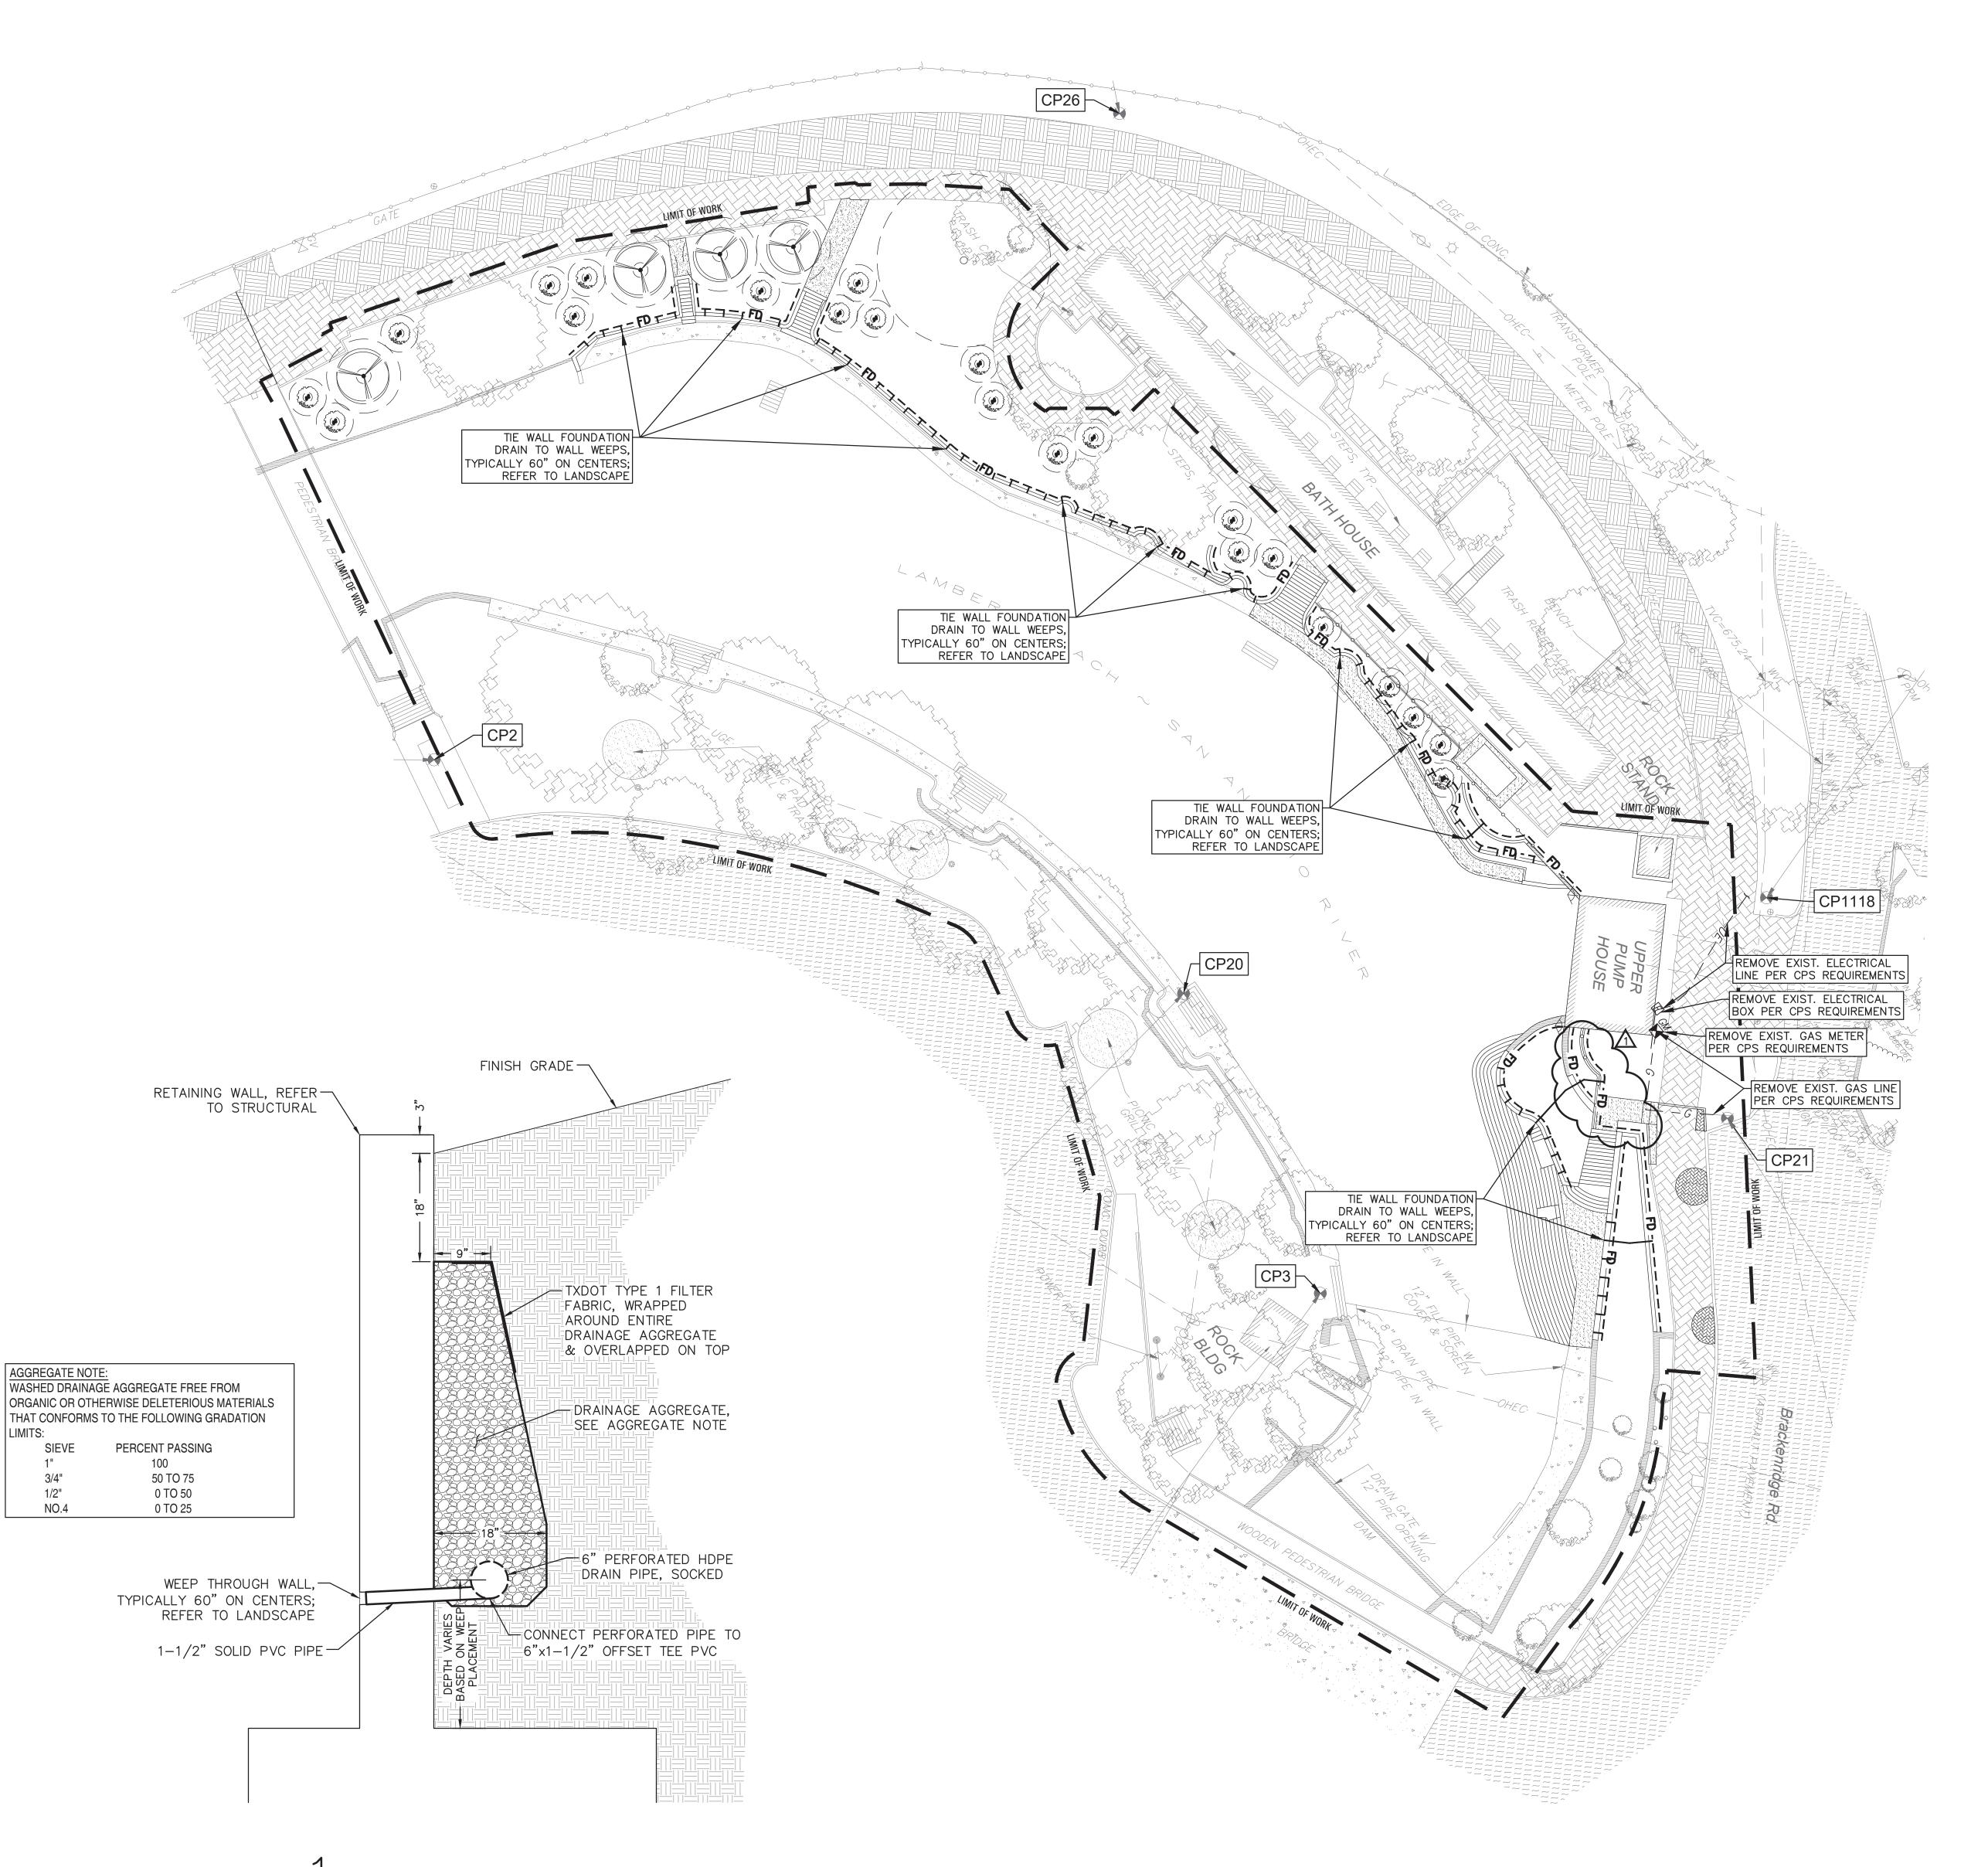
Job Number CNOS701

Scale

North

Drawing Title GRADING PLAN at LAMBERT BEACH

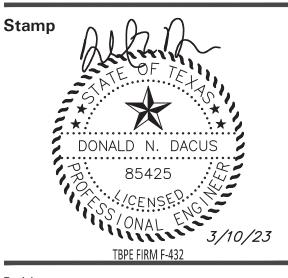



WALL FOUNDATION DRAIN DETAIL NOT TO SCALE

(IN FEET) SCALE 1" = 20'

LEGEND

NEW WALL FOUNDATION DRAIN PIPE, SEE DETAIL 1 THIS SHEET

SHEET NOTES:

1. REFER TO SHEET C1.01 EXISTING CONDITIONS PLAN at LAMBERT BEACH FOR NOTES & LEGEND



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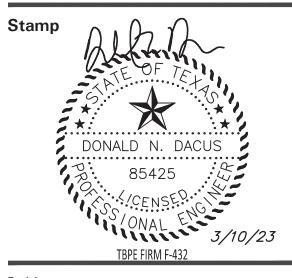
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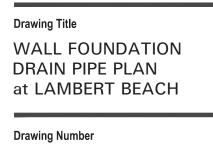
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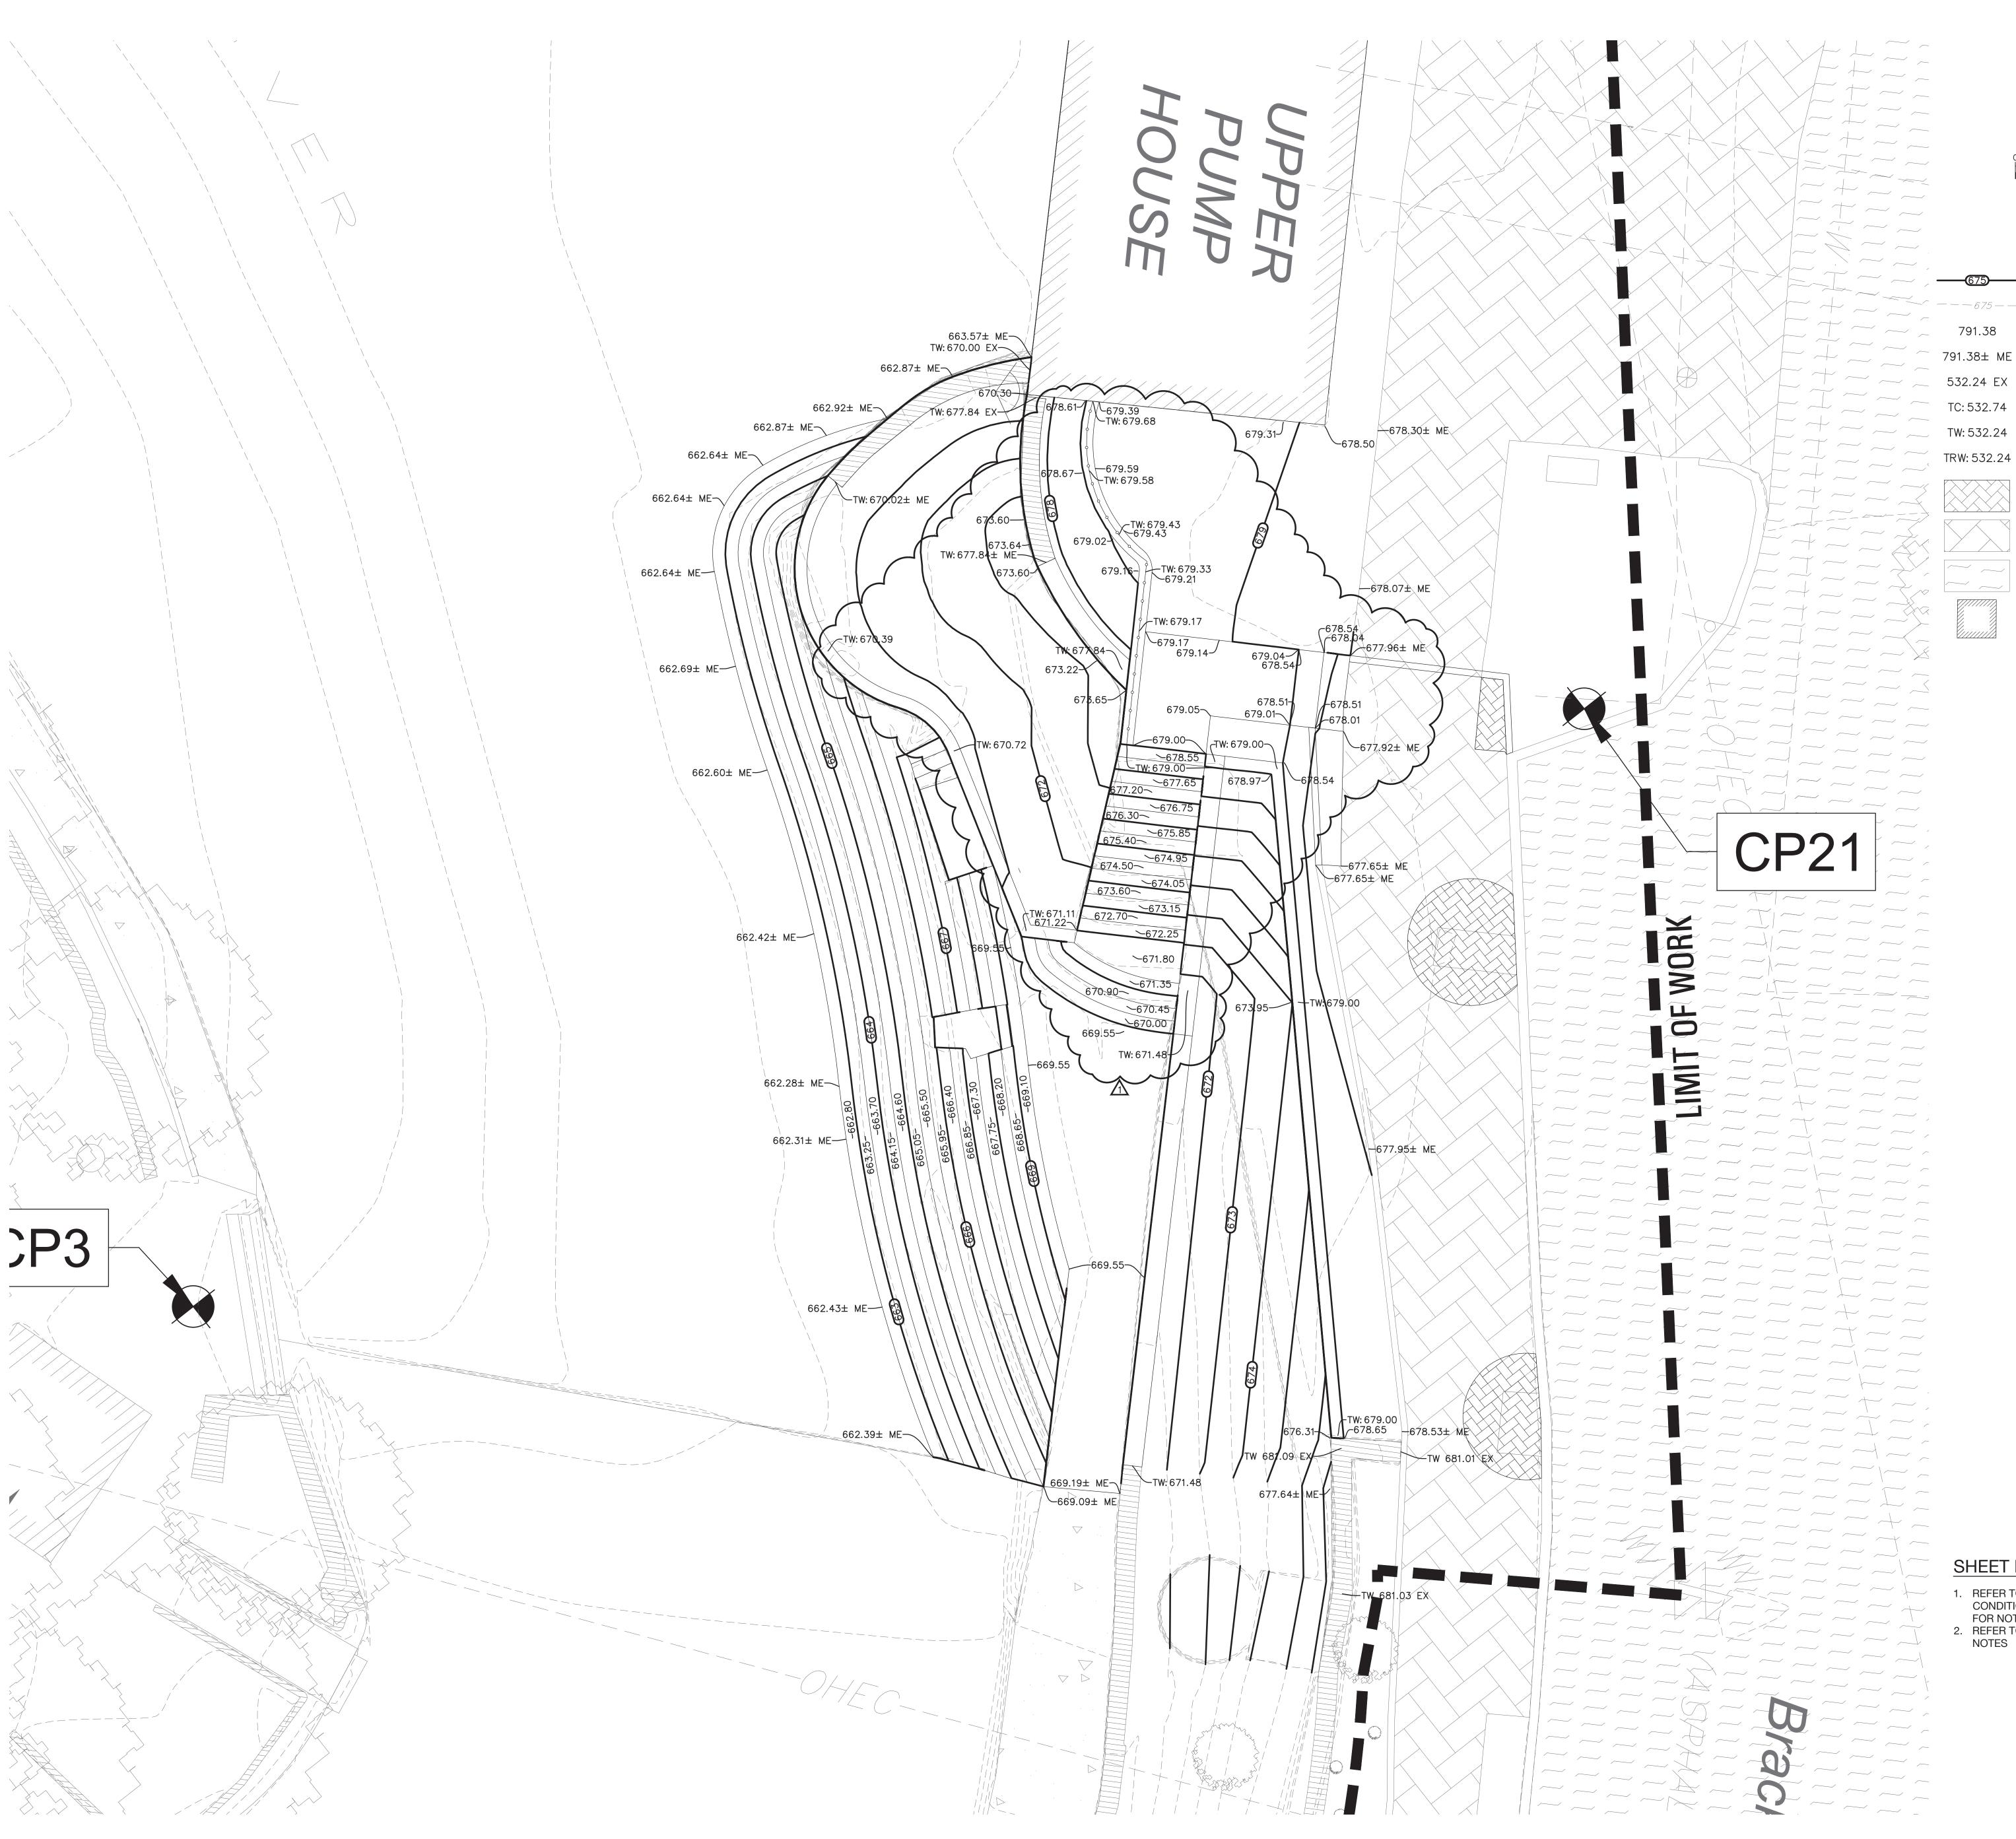
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Scale

North







(IN FEET) SCALE 1" = 5'

LEGEND

NEW CONTOUR
EXISTING CONTOUR
NEW SPOT ELEVATION
MATCH EXISTING SPOT ELEVATION
EXISTING SPOT ELEVATION
NEW TOP OF CURB ELEVATION
NEW TOP OF WALL ELEVATION
NEW TOP OF RIVER WALL ELEVATIO
NEW PAVER INFILL

EXISTING PAVERS

EXISTING ASPHALT PAVEMENT

EXISTING BUILDING OUTLINE

SHEET NOTES:

- 1. REFER TO SHEET C1.01 EXISTING CONDITIONS PLAN at LAMBERT BEACH
- FOR NOTES & LEGEND 2. REFER TO SHEET C1.41 FOR GRADING NOTES



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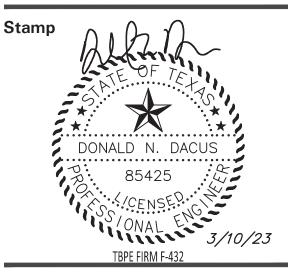
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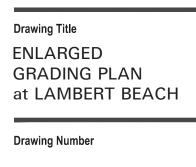
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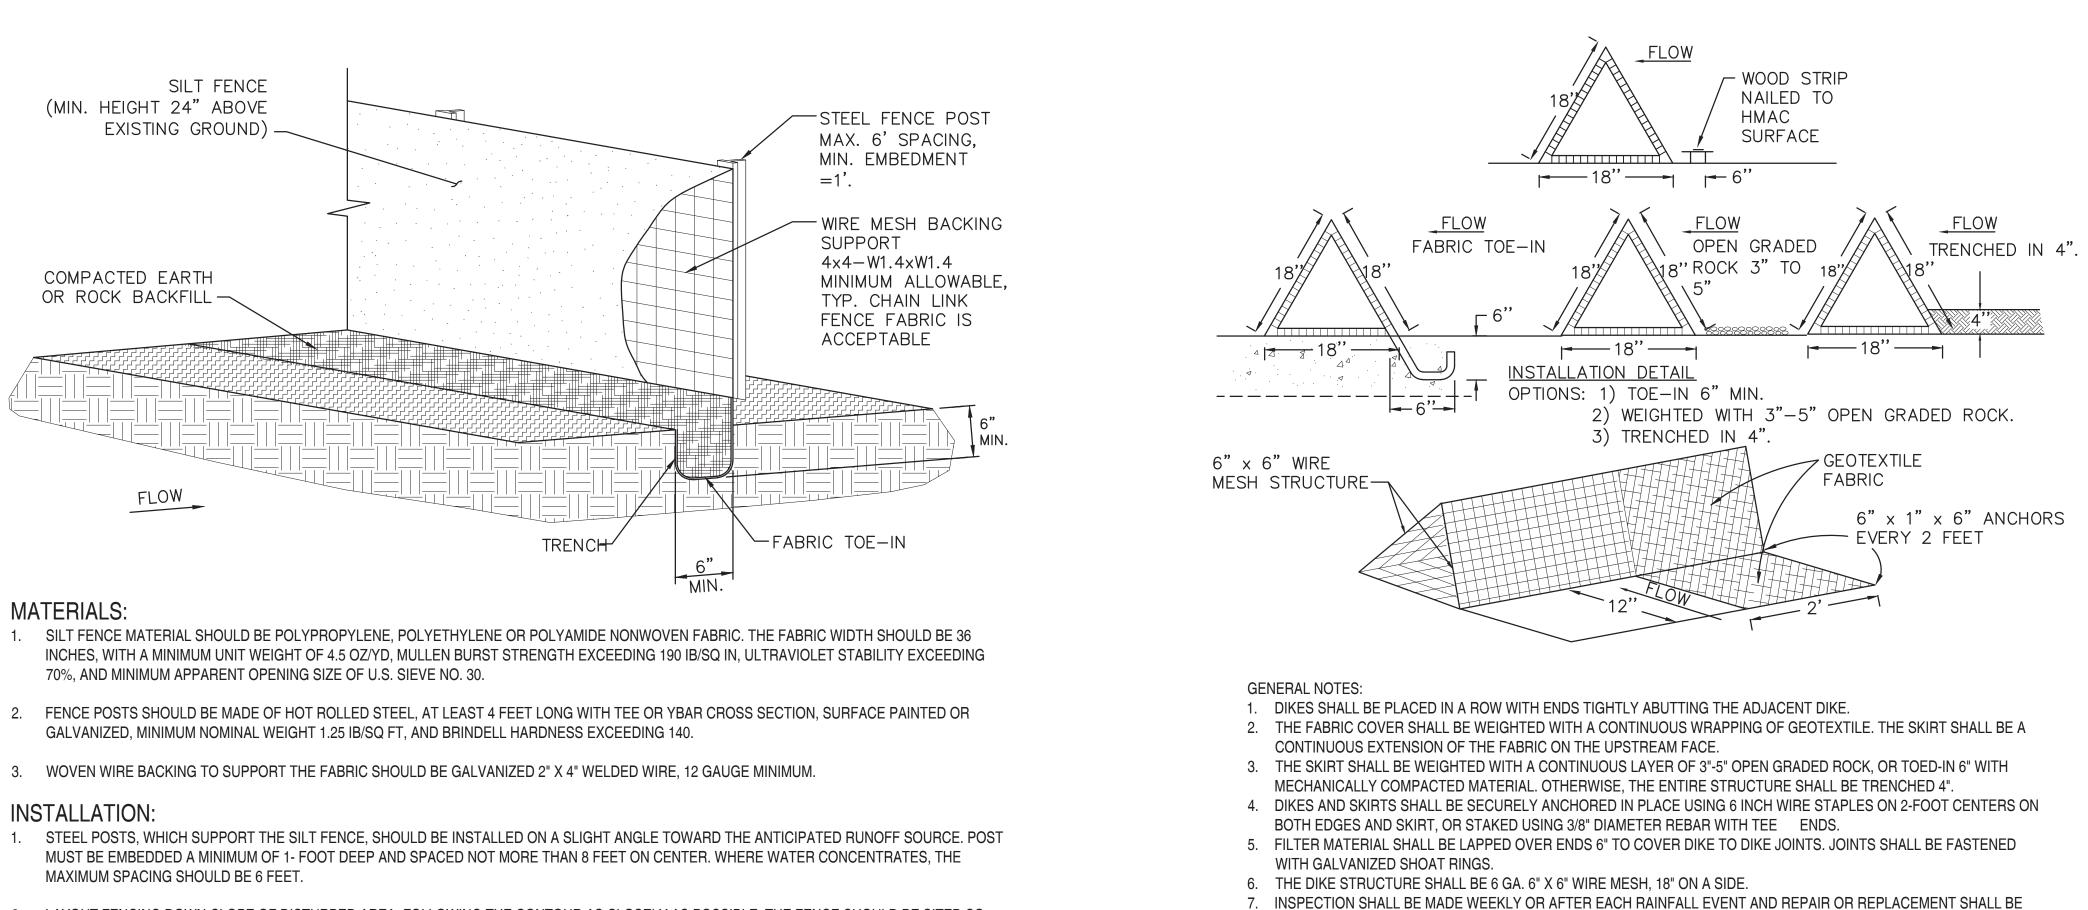


EROSION CONTROL NOTES:

- ANY MAJOR VARIATION IN MATERIALS OR LOCATIONS OF CONTROLS OR FENCES FROM THOSE SHOWN ON THE APPROVED PLANS WILL REQUIRE A REVISION AND MUST BE APPROVED BY THE DESIGN ENGINEER. MINOR REVISIONS TO BE MADE AS FIELD REVISIONS TO THE STORMWATER POLLUTION PREVENTION PLAN MAY BE REQUIRED DURING THE COURSE OF CONSTRUCTION TO CORRECT CONTROL INADEQUACIES.
- 2. INSPECT THE CONTROLS AND FENCES AT WEEKLY INTERVALS AND AFTER SIGNIFICANT RAINFALL EVENTS TO INSURE THAT THEY ARE FUNCTIONING PROPERLY. THE PERSON(S) RESPONSIBLE FOR MAINTENANCE OF CONTROLS AND FENCES SHALL IMMEDIATELY MAKE ANY NECESSARY REPAIRS TO DAMAGED AREAS. SILT ACCUMULATION AT CONTROLS MUST BE REMOVED WHEN THE DEPTH REACHES SIX INCHES (6").
- 3. PRIOR TO FINAL ACCEPTANCE, HAUL ROADS AND WATERWAY CROSSINGS CONSTRUCTED FOR TEMPORARY CONTRACTOR ACCESS MUST BE REMOVED, ACCUMULATED SEDIMENT REMOVED FROM THE WATERWAY, AND THE AREA RESTORED TO THE ORIGINAL GRADE AND REVEGETATED. DISPOSE ALL LAND CLEARING DEBRIS IN APPROVED SPOIL DISPOSAL SITES. REFER TO SPECIFICATIONS, SECTION 01 57 13 - TEMPORARY EROSION & SEDIMENT CONTROL.
- 4. RESTORE ALL DISTURBED AREAS IN ACCORDANCE WITH LANDSCAPE PLANS AND SPECIFICATIONS.
- CONTRACTOR SHALL TAKE ALL NECESSARY PRECAUTIONS (USE OF SILT FENCES, ETC.) TO KEEP DRAINAGE AND SILT FROM WASHING ONTO ADJACENT PROPERTY OR CROSSING ADJACENT STREETS. CONTRACTOR SHALL IMMEDIATELY REMOVE SILT/ DEBRIS THAT WASH OFFSITE OR INTO EXISTING STORM DRAIN SYSTEMS.
- 6. CONTRACTOR SHALL EXECUTE ALL REQUIRED PROVISIONS OF THE STORM WATER POLLUTION PREVENTION AND EROSION CONTROL PLAN. ANY FINE RESULTING FROM FAILURE TO EXECUTE REQUIRED PROVISIONS WILL BE AT THE CONTRACTOR'S EXPENSE.
- 7. THE CONTRACTOR MUST HAVE A DESIGNATED PERSON RESPONSIBLE FOR MONITORING EROSION CONTROL MEASURES TO INSURE THAT ALL FEDERAL, STATE, AND LOCAL LAWS AND REGULATIONS ARE BEING COMPLIED WITH. THIS PERSON SHALL BE RESPONSIBLE FOR ALL REQUIRED FORMS AND DOCUMENTATION TO MEET REGULATIONS OF THE EPA, NPDES, AND TPDES GENERAL PERMIT.
- 8. IN THE EVENT OF UNUSUAL SITE CONDITIONS, OR WEATHER RELATED EVENTS, MORE STRINGENT REQUIREMENTS MAY BE REQUIRED (ON-SITE OR OFF) TO MAINTAIN EROSION CONTROL.
- 9. SEE SHEET C1.11 EROSION & SEDIMENT CONTROL PLAN FOR ADDITIONAL INFORMATION.

EROSION AND SEDIMENTATION MISCELLANEOUS POLLUTION CONTROLS


- 1. MUD/DIRT INADVERTENTLY TRACKED OFFSITE AND ONTO PUBLIC STREETS SHALL BE REMOVED IMMEDIATELY BY HAND OR MECHANICAL BROOM SWEEPING.
- 2. CONSTRUCTION AND WASTE MATERIALS SHALL BE STORED WITHIN A DESIGNATED STORAGE AREA. BULK MATERIALS SUCH AS SAND, TOPSOIL, ETC. WILL BE BORDERED ON THE DOWN GRADIENT SIDES WITH A SILT FENCE. A LIST OF MATERIALS TO BE STORED ON-SITE SHOULD BE RECORDED AND REGULARLY UPDATED ON THE "ON-SITE MATERIAL LIST."
- 3. AN AREA SHALL BE DESIGNATED AS A CONSTRUCTION EQUIPMENT STORAGE AREA. CONSTRUCTION EQUIPMENT (EXCEPT LARGE SLOW MOVING EQUIPMENT) NOT REMOVED FROM THE SITE AT NIGHT SHALL BE STORED IN THE CONTAINMENT AREA.
- 4. EXCAVATION SPOILS TEMPORARILY STORED ONSITE, PENDING OFFSITE DISPOSAL IN ACCORDANCE WITH APPLICABLE REGULATIONS, SHALL BE BORDERED ON THE DOWN GRADIENT SIDE BY A SILT FENCE.
- 5. THE DESIGNATED CONSTRUCTION STORAGE AREA SHALL HAVE A SINGLE ENTRANCE AND WILL BE BORDERED ON THE DOWNGRADIENT SIDES BY A SILT FENCE AND/OR TRIANGULAR FILTER DIKE.
- 6. SEDIMENT COLLECTED BEHIND THE SILT FENCE WILL BE PERIODICALLY COLLECTED AND PLACED AS FILL MATERIAL WITHIN THE PROPERTY. CONTAMINATED SEDIMENTS WILL BE DISPOSED OFFSITE IN ACCORDANCE WITH APPLICABLE REGULATIONS.
- 7. THE USE OF ON-SITE TEMPORARY CONSTRUCTION FUEL STORAGE TANKS IS LIMITED TO TANK SIZES WHICH CAN ONLY STORE UNREGULATED QUANTITIES OF FUEL.
- 8. INTENTIONAL RELEASE OF VEHICLE OR EQUIPMENT FLUID ONTO THE GROUND IS PROHIBITED. TAINTED SOIL RESULTING FROM ACCIDENTAL SPILLS SHALL BE REMOVED AND DISPOSED OF OFFSITE IN ACCORDANCE WITH APPLICABLE REGULATIONS.
- 9. SCHEDULED CONSTRUCTION EQUIPMENT AND VEHICLE MAINTENANCE ACCOMPLISHED ON-SITE SHALL BE DONE WITHIN THE CONSTRUCTION EQUIPMENT AND VEHICLE STORAGE AREA.
- 10. A CONTROLLED AREA ON-SITE SHALL BE DESIGNATED AS A RINSE-OUT PIT FOR CONCRETE TRUCKS. RINSE-OUT PITS SHALL BE SURROUNDED BY BERM OR HAY BALES TO PREVENT RUNOFF OF CONTAMINATED WATER. THE CONTRACTOR WILL ADVISE HIS CONCRETE SUPPLIERS OF THE REQUIREMENTS TO UTILIZE THE RINSE-OUT PITS FOR THE INTENDED PURPOSE.
- 11. ADDITIONAL RINSE-OUT PITS MAY BE ADDED AS CONSTRUCTION CONDITIONS REQUIRE. THE CONTRACTOR WILL ADVISE HIS CONCRETE SUPPLIERS OF THE REQUIREMENTS TO UTILIZE THE RINSE-OUT PITS FOR THE INTENDED PURPOSE.
- 12. CONSTRUCTION WASTE MATERIALS, DOMESTIC GARBAGE, ETC. SHALL BE PERIODICALLY COLLECTED AND DISPOSED OFFSITE IN ACCORDANCE WITH APPLICABLE REGULATIONS.
- 13. TRASH RECEPTACLES WILL BE ESTABLISHED AT STORAGE LOCATIONS, IN THE VICINITY OF EQUIPMENT STORING AND NEAR THE CONSTRUCTION AREAS. RECEPTACLES SHALL BE EMPTIED AS REQUIRED AND DISPOSED OFFSITE IN ACCORDANCE WITH APPLICABLE REGULATIONS.



- 2. LAYOUT FENCING DOWN-SLOPE OF DISTURBED AREA, FOLLOWING THE CONTOUR AS CLOSELY AS POSSIBLE. THE FENCE SHOULD BE SITED SO THAT THE MAXIMUM DRAINAGE AREA IS 1/4 ACRE PER 100 FEET OF FENCE.
- 3. THE TOE OF THE SILT FENCE SHOULD BE TRENCHED IN WITH A SPADE OR MECHANICAL TRENCHER, SO THAT THE DOWN-SLOPE FACE OF THE TRENCH IS FLAT AND PERPENDICULAR TO THE LINE OF FLOW. WHERE FENCE CANNOT BE TRENCHED IN (E.G., PAVEMENT OR ROCK OUTCROP), WEIGHT FABRIC FLAP WITH 3 INCHES OF PEA GRAVEL ON UPHILL SIDE TO PREVENT FLOW FROM SEEPING UNDER FENCE.
- 4. THE TRENCH MUST BE A MINIMUM OF 6 INCHES DEEP AND 6 INCHES WIDE TO ALLOW FOR THE SILT FENCE FABRIC TO BE LAID IN THE GROUND AND BACKFILLED WITH COMPACTED MATERIAL.
- 5. SILT FENCE SHOULD BE SECURELY FASTENED TO EACH STEEL SUPPORT POST OR TO WOVEN WIRE, WHICH IS IN TURN ATTACHED TO THE STEEL FENCE POST. THERE SHOULD BE A 3-FOOT OVERLAP, SECURELY FASTENED WHERE ENDS OF FABRIC MEET.
- 6. SILT FENCE SHALL NOT BE PLACED IN CHANNELS OR WATERWAYS AND SHALL FOLLOW CONTOURS AS CLOSELY AS POSSIBLE.
- 7. SLOPE INTO SILT FENCE SHALL NOT EXCEED 20% OR ANOTHER FORM OF TBMP SHALL BE IMPLEMENTED.



- MADE PROMPTLY AS NEEDED BY THE CONTRACTOR. 8. ACCUMULATED SILT SHALL BE REMOVED WHEN IT REACHES A DEPTH OF 6", AND DISPOSED OF IN A MANNER WHICH WILL NOT CAUSE ADDITIONAL SILTATION. 9. AFTER THE DEVELOPMENT SITE IS COMPLETELY STABILIZED, THE DIKES AND ANY REMAINING SILT FENCE SHALL BE
- REMOVED. SILT SHALL BE DISPOSED OF AS INDICATED IN NOTE 8 ABOVE. TRIANGULAR FILTER DIKE DETAIL NOT TO SCALE

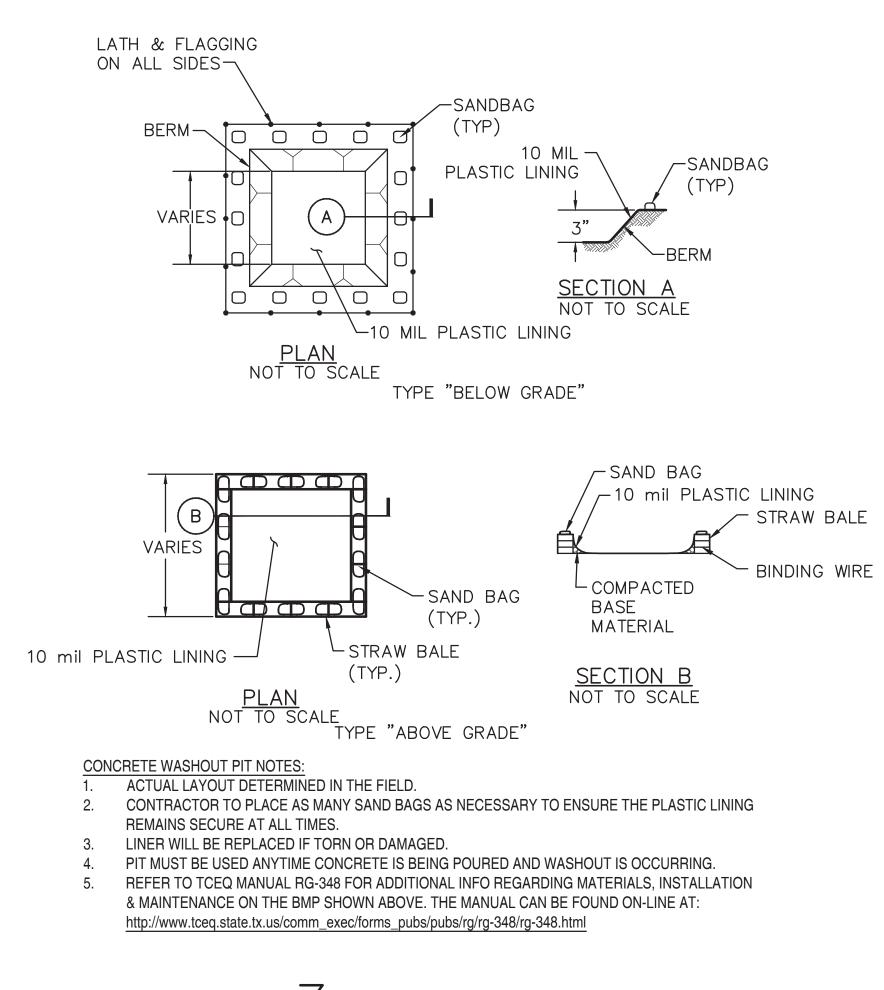

CONCRETE WASHOUT PIT NOT TO SCALE



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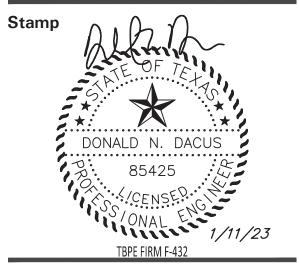
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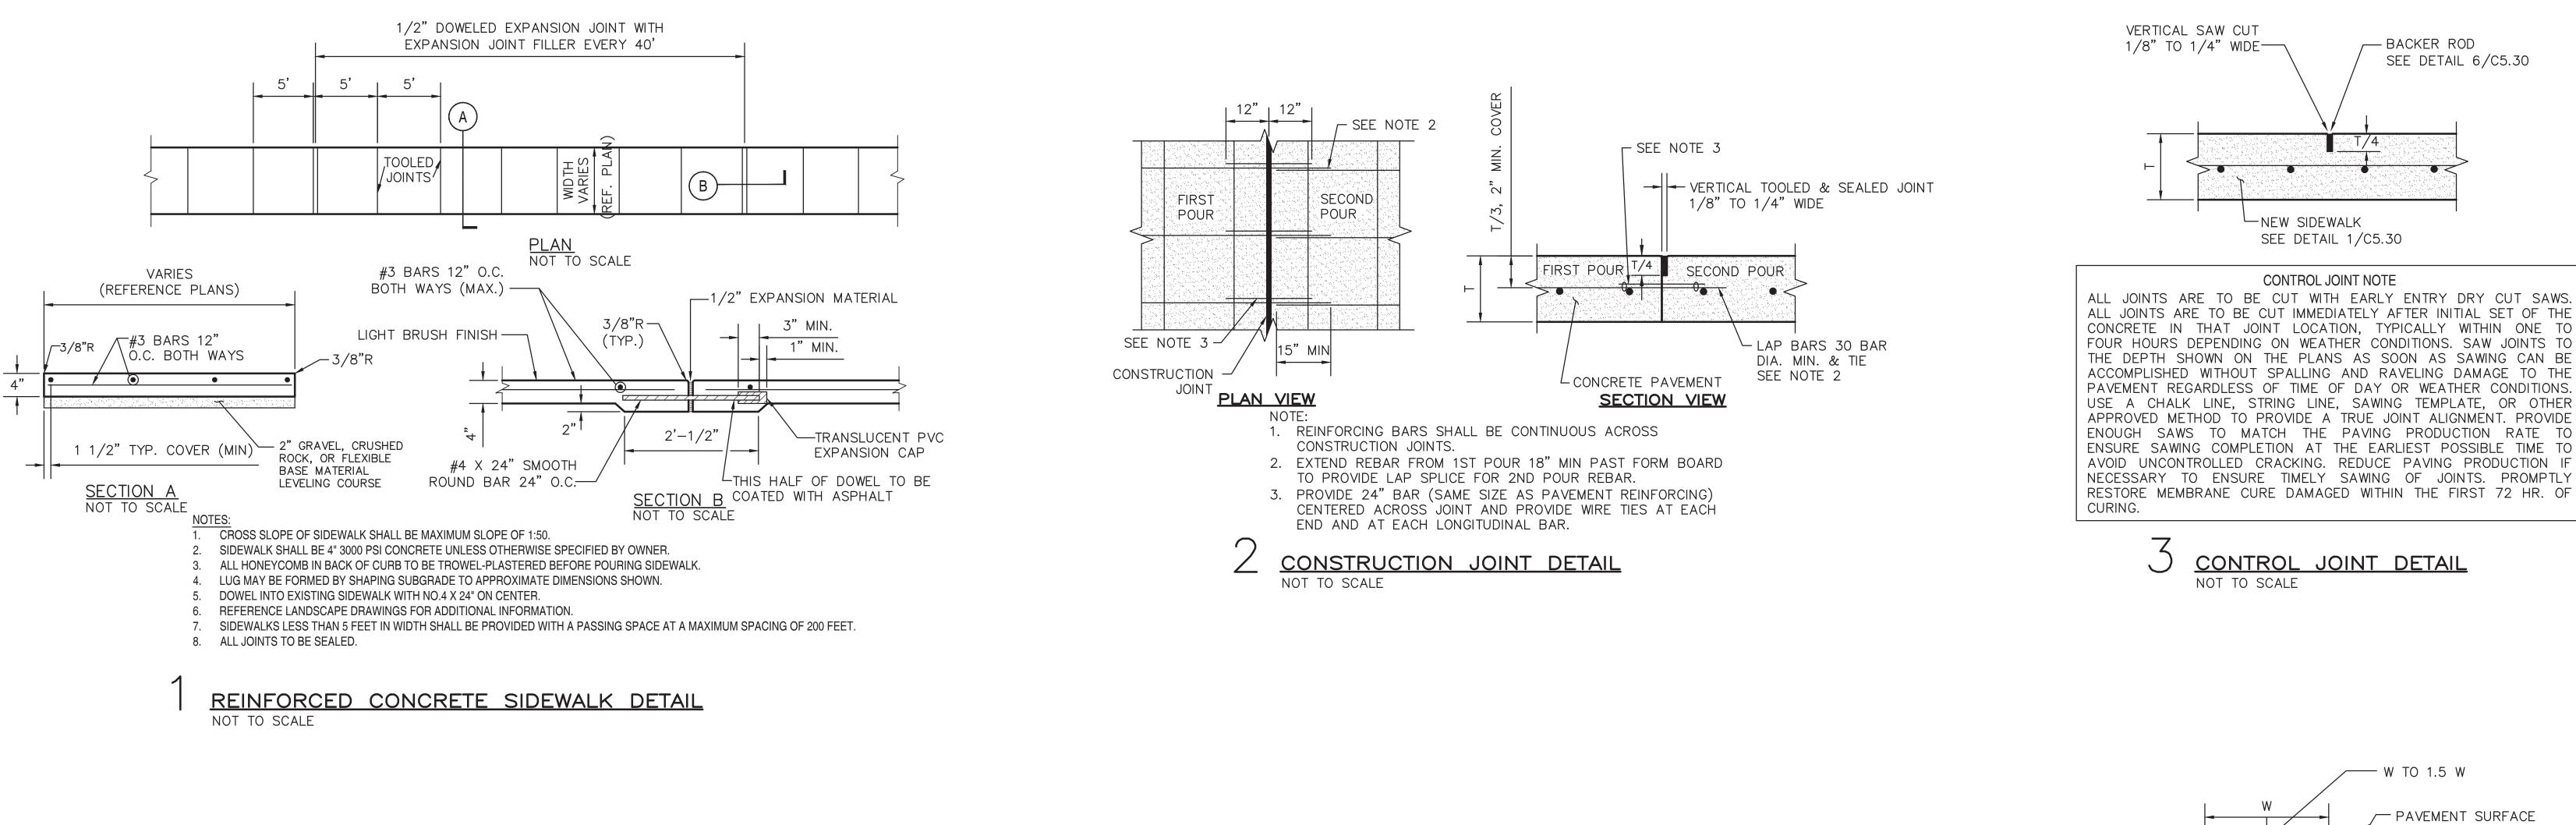
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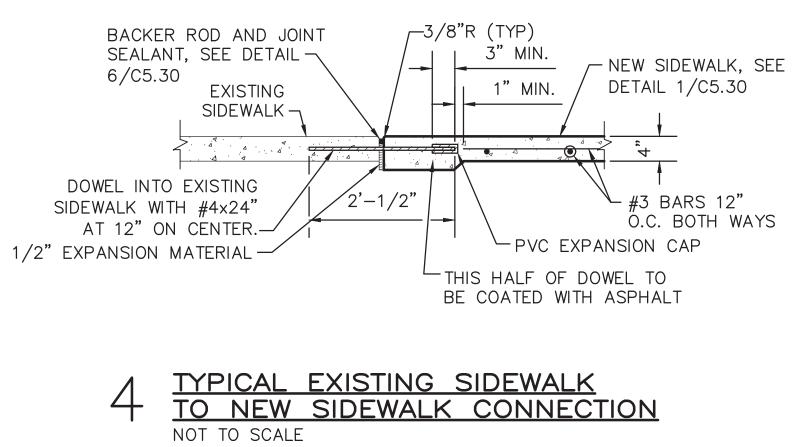
CNOS701

Scale

Drawing Title **EROSION & SEDIMENT CONTROL** NOTES & DETAILS







SEE DETAIL 1/C5.30 1/2" T/4" JOINT ŚEALANT EXPANSION JOINT FILLER D. A $\triangle \qquad \sum_{i}$ 4'-0" -EXISTING OR NEW CONCRETE -STRUCTURE ISOLATION JOINT DETAIL

NOT TO SCALE



NOTES:

1. W = JOINT WIDTH

- 2. T = SLAB THICKNESS
- 3. JOINT SEALANT SHALL BE COLD POUR JOINT SEALANT, BASF SONOLASTIC SL 1 OR APPROVED EQUAL.

~

JOINT SEALANT (SEE NOTE)

-CLOSED CELL BACKER ROD,


COMPOSITION. DIAMETER -

POLYURETHANE

W+ 1/8 IN.



VOID SPACE

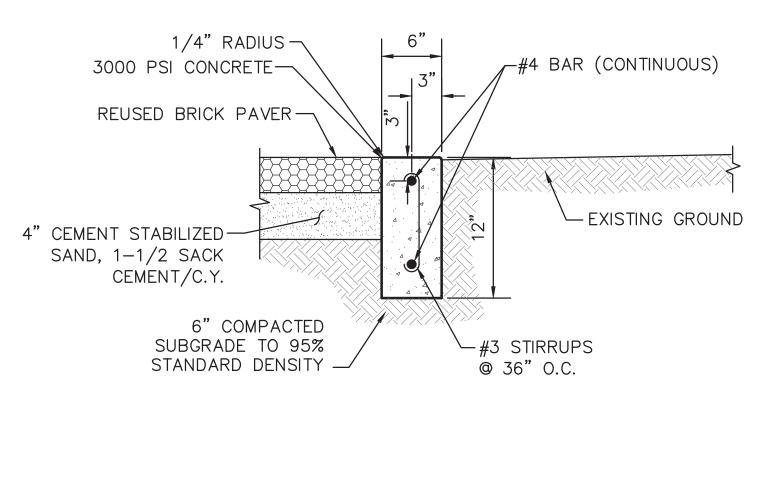





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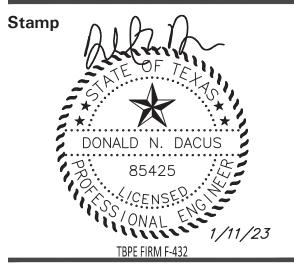
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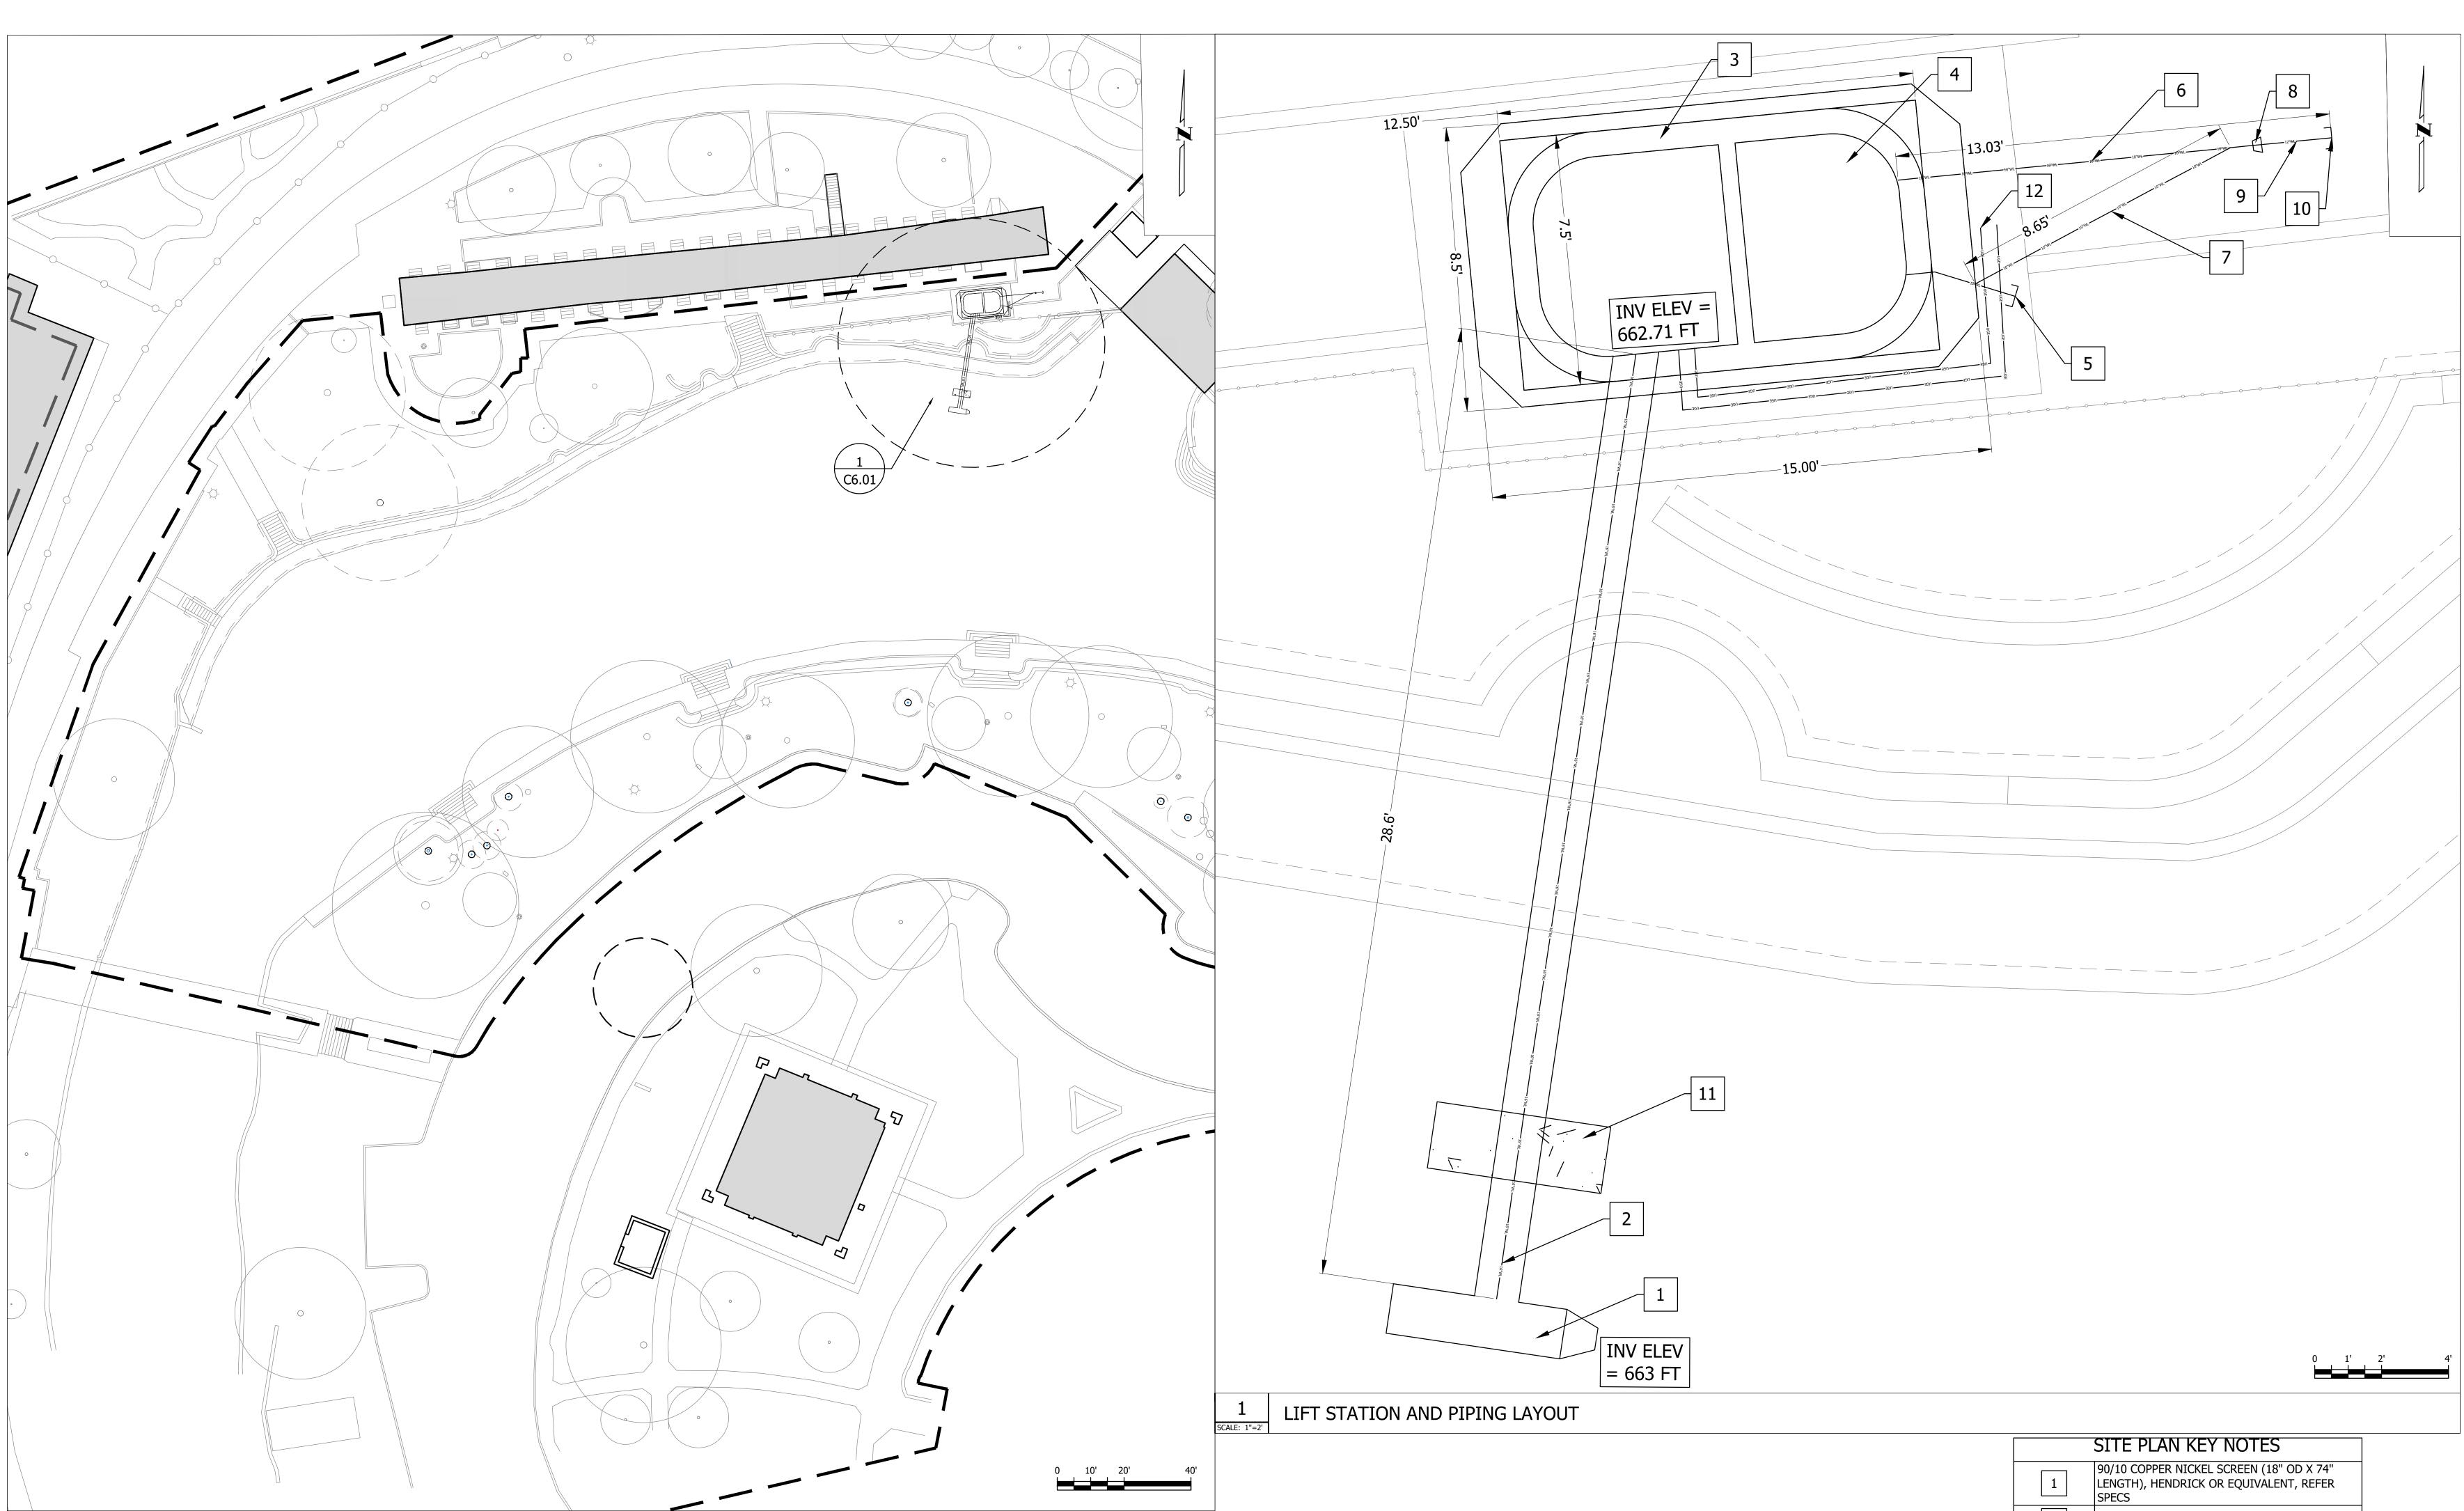
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Date 11 JANUARY 2023		
Phase 95% CONSTRUCTION DOCUMENTS		
Job Number CNOS701		
Scale	North	
Drawing Title		





	SITE PLAN KEY NOTES
1	90/10 COPPER NICKEL SCREEN (18" OD X 74" LENGTH), HENDRICK OR EQUIVALENT, REFER SPECS
2	16" DUCTILE IRON WATER INTAKE PIPE
3	ONE LIFT STATION, OLDCASTLE OR EQUIVALENT, REFER SHEET C6.02
4	INTEGRAL VALVE BOX WITHIN ONE LIFT STATION
5	10" DUCTILE IRON BLIND FLANGE
6	10" WATER DISCHARGE DUCTILE IRON LINE
7	10" WATER DISCHARGE DUCTILE IRON LINE
8	10"/12" DUCTILE IRON REDUCER
9	12" DUCTILE IRON FORCE MAIN LINE
10	12" DUCTILE IRON BLIND FLANGE
11	CONCRETE PIPE CRADLE, REFER SHEET C6.02
12	TWO 2-IN CONDUITS FOR POWER/CONTROL CAP AT END

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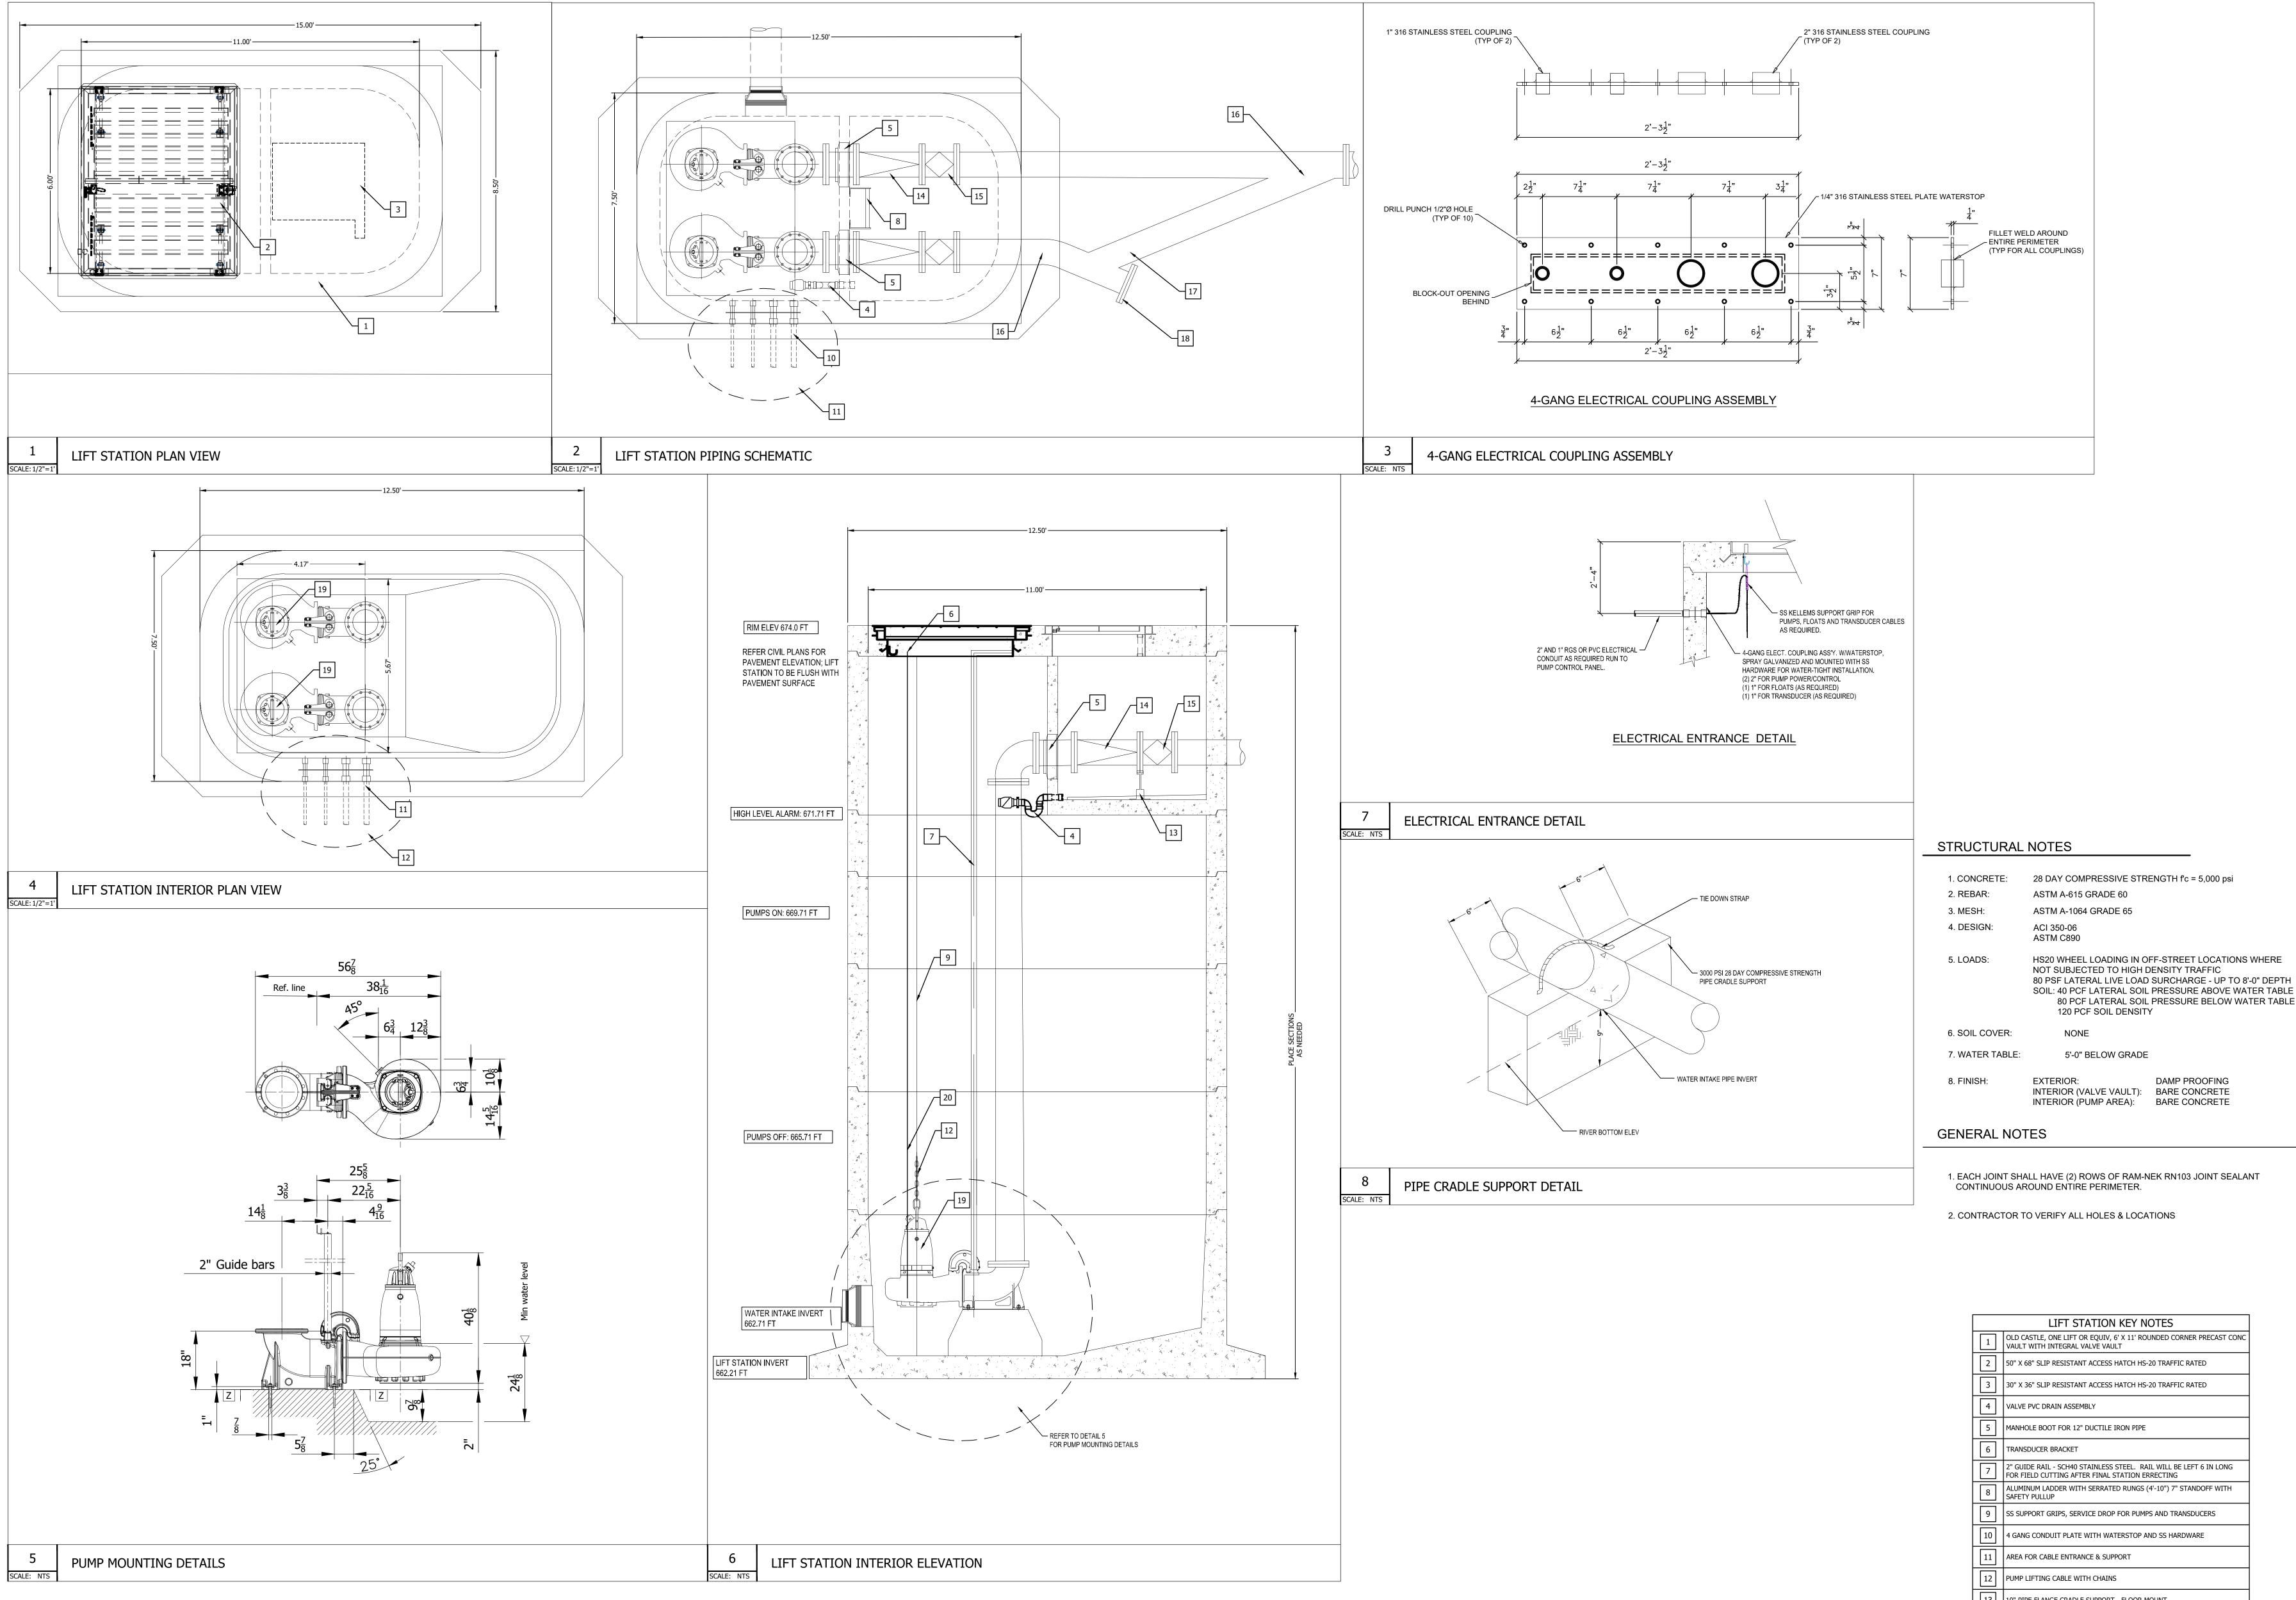
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Date 11TH JANUARY 2023 Phase 95% CONSTRUCTION DOCUMENTS Job Number CNOS701	
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Drawing Title	
LIFT STATION AND LAYOUT	PIPING
Drawing Number	
C6.01	



	LIFT STATION KEY NOTES
1	OLD CASTLE, ONE LIFT OR EQUIV, 6' X 11' ROUNDED CORNER PRECAST CONC VAULT WITH INTEGRAL VALVE VAULT
2	50" X 68" SLIP RESISTANT ACCESS HATCH HS-20 TRAFFIC RATED
3	30" X 36" SLIP RESISTANT ACCESS HATCH HS-20 TRAFFIC RATED
4	VALVE PVC DRAIN ASSEMBLY
5	MANHOLE BOOT FOR 12" DUCTILE IRON PIPE
6	TRANSDUCER BRACKET
7	2" GUIDE RAIL - SCH40 STAINLESS STEEL. RAIL WILL BE LEFT 6 IN LONG FOR FIELD CUTTING AFTER FINAL STATION ERRECTING
8	ALUMINUM LADDER WITH SERRATED RUNGS (4'-10") 7" STANDOFF WITH SAFETY PULLUP
9	SS SUPPORT GRIPS, SERVICE DROP FOR PUMPS AND TRANSDUCERS
10	4 GANG CONDUIT PLATE WITH WATERSTOP AND SS HARDWARE
11	AREA FOR CABLE ENTRANCE & SUPPORT
12	PUMP LIFTING CABLE WITH CHAINS
13	10" PIPE FLANGE CRADLE SUPPORT - FLOOR MOUNT
14	12" MUELLER SWING CHECK VALVE - FL. X FL. OR EQUIVALENT
15	12" A-2361 MUELLER RESILIENT WEDGE GATE VALE OR EQUIVALENT
16	10" 22.5 DEG DUCTILE IRON BEND
17	10" 45 DEG DUCTILE IRON WYE
18	10" DUCTILE IRON BLIND FLANGE
19	FLYGT PUMP NP3153 LT 3 ~ 622 OR EQUIVALENT
20	TRANSDUCER FOR PUMP CONTROL

BRACKENRIDGE PARK SAN ANTONIO, TX

CLIENT: CITY OF SAN ANTONIO PUBLIC WORKS DEPARTMENT (TCI) PO BOX 839966, SAN ANTONIO TX 78283-3966

LANDSCAPE ARCHITECT



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OVERLAND PARTNERS ARCHITECT 203 E. JONES AVE., SUITE 104 SAN ANTONIO, TX 78215

SEVENTH GENERATION DESIGN HISTORIC ARCHITECT 933 NORTH FLORES STREET, SUITE B SAN ANTONIO, TX 78212

WORK5HOP CONSTRUCTION OBSERVATION 203 E. JONES AVE., SUITE 104 SAN ANTONIO, TX 78215

LUNDY & FRANKE ENGINEERING STRUCTURAL ENGINEER 549 HEIMER SAN ANTONIO, TX 78232

INTELLIGENT ENGINEERING SERVICES CIVIL ENGINEER 1045 CENTRAL PARKWAY NORTH, SUITE 200, SAN ANTONIO, TX 78232

TRUE NORTH CONSULTING GROUP IT AND COMMUNICATIONS 13284 POND SPRINGS ROAD, STE. 304 AUSTIN TX, 78729

CNG ENGINEERING MEP

1917 N. NEW BRAUNFELS AVE., SUITE 201, SAN ANTONIO TX, 78208

WGI ENGINEERING HYDROLOGY 5710 W HAUSMAN RD. SAN ANTONIO, TX 78249

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Date 11TH JANUARY 2023	
Phase 95% construction documents	
Job Number CNOS701	
Scale North	
AS NOTED	
Drawing Title	
LIFT STATION DETAILS	
Drawing Number	
C6.02	

TREE REMOVAL NOTES:

- 1. "TREES TO BE REMOVED UNDER HISTORIAN OVERSIGHT" PER LEGEND WILL REQUIRE A HISTORIAN (PROVIDED BY PWD EMD) TO BE PRESENT BEFORE REMOVAL ACTIVITIES CAN BEGIN, TO ENSURE NO DAMAGE OCCURS TO HISTORIC STANDING STRUCTURES.
- 2. DO NOT STAGE EQUIPMENT ON OR NEAR HISTORIC RIVER WALLS OR HISTORIC STRUCTURES. EXACT DISTANCE WILL DEPEND ON CONDITION OF HISTORIC STRUCTURE. SUPPORT WILL BE PROVIDED BY THE MONITOR ON SITE.
- 3. IF HEAVY EQUIPMENT (SKID LOADER AND UP) IS TO BE USED NEAR A HISTORIC STRUCTURE, USE EDM APPROVED METHODS OF PROTECTION. CONTACT THE PWD EMD ARCHITECTURAL HISTORIAN (210-207-1454) FOR GUIDANCE.
- CONTRACTOR TO LIMIT SOIL DISTURBANCE OUTSIDE OF 5' RADIAL PERIMETER OF ROOTBALL DURING TREE REMOVAL.
- 5. ALL TREES TO BE REMOVED SHALL BE MARKED PER TECHNICAL SPECIFICATIONS AND REMOVED UPON REVIEW AND APPROVAL BY OWNER AND LANDSCAPE ARCHITECT.
- 6. ALL TREES IN AREAS NOT MARKED FOR REMOVAL SHALL REMAIN UNLESS OTHERWISE NOTED. ANY TREE THAT DOES NOT APPEAR ON THE TREE SURVEY SHALL BE VERIFIED WITH THE OWNER AND LANDSCAPE ARCHITECT TO DETERMINE STATUS OF REMOVAL.
- ALL TREES REMOVED EXCEPT THOSE DESIGNATED FOR THE SALVAGE OF TIMBER BY OWNER SHALL BE MULCHED ON SITE INCLUDING ALL LIMB/BRACH DEBRIS AND TRUNK. MULCH GRIND SHALL BE STORED ON SITE UNLESS OTHERWISE NOTED. REFER TO SPECIFICATIONS FOR **REMOVAL AND STORAGE INFORMATION.**

EXISTING TREE MAINTENANCE NOTES:

- TREE MAINTENANCE SHALL OCCUR AS NOTED FOR ALL EXISTING TREES AS REQUIRED PER TECHNICAL SPECIFICATIONS ISSUED. SUCH OPERATIONS MAY INCLUDE TRIMMING, PRUNING, FERTILIZING, WATERING, ROOT PRUNING AND/OR FOLIAGE WASHING AS REQUIRED BY SITE ARBORIST OR LANDSCAPE ARCHITECT.
- 2. TREE MAINTENANCE OPERATIONS SHALL BE DEEMED HIGH PRIORITY AND SHALL OCCUR WHEN SUCH NOTED OPERATIONS ARE NOTED TO OCCUR AND SHALL OCCUR AS NOTED BY ARBORIST.

GENERAL TREE PROTECTION NOTES:

- 1. ALL TREES INDICATED ON THE TREE PRESERVATION PLANS TO BE PROTECTED SHALL BE PROTECTED WITH TEMPORARY FENCING THROUGHOUT CONSTRUCTION.
- 2. TREE PROTECTION FENCES SHALL BE INSTALLED PRIOR TO THE COMMENCEMENT OF ANY DEMOLITION AND/OR SITE PREPARATION WORK (CLEARING OR GRUBBING).
- 3. FENCES SHALL COMPLETELY SURROUND THE TREE OR CLUSTERS OF TREES; FENCES SHALL BE LOCATED AT THE OUTERMOST LIMITS OF THE TREE BRANCHES (DRIP LINE); AND SHALL BE MAINTAINED THROUGHOUT THE CONSTRUCTION PROJECT. FENCES MAY BE MOVED OR REMOVED TO ENABLE THE PROGRESS OF CONSTRUCTION ONLY AS APPROVED BY THE LANDSCAPE ARCHITECT.
- 4. WHERE EXCEPTIONS RESULT IN A FENCE BEING CLOSER THAN 4 FEET TO A TRUNK, PROTECT THE TRUNK WITH STRAPPED-ON PLANKING TO A HEIGHT OF 8' (OR TO THE LIMITS OF THE LOWER BRANCHING) AS INDICATED ON TREE PRESERVATION PLANS.
- 5. COVER THE ROOT ZONE AREA WITH 4" OF HARDWOOD MULCH, UNDER DIRECTION OF THE LANDSCAPE ARCHITECT, WHERE ROOT ZONES WITHIN DRIP LINES ARE UNPROTECTED BY FENCING.
- 6. ANY ROOT SEVERED BY CONSTRUCTION ACTIVITY SHALL BE PRUNED FLUSH WITH THE SOIL. BACKFILL ROOT AREAS WITH SPECIFIED TOP SOIL AS SOON AS POSSIBLE. IF EXPOSED ROOT AREAS ARE NOT BACKFILLED WITHIN 2 DAYS, COVER THEM WITH SPECIFIED ORGANIC MATERIAL. THE OWNER AND LANDSCAPE ARCHITECT MUST BE NOTIFIED IMMEDIATELY OF ANY DAMAGE TO PRESERVED TREES.
- TREES HEAVILY IMPACTED BY CONSTRUCTION ACTIVITIES SHALL BE 7 WATERED THOROUGHLY ONCE A WEEK DURING PERIODS OF HOT, DRY WEATHER AS DIRECTED BY THE LANDSCAPE ARCHITECT. TREE CROWNS SHALL BE SPRAYED WITH WATER PERIODICALLY TO REDUCE DUST ACCUMULATION ON THE LEAVES.

GENERAL TREE PROTECTION NOTES (CONT.)

- OF SAN ANTONIO ARBORIST.
- ROOT ENDS FROM CONCRETE AND LIME.
- DIRECTED BY CITY ARBORIST.
- 6. EQUIPMENT.
- 8.
- (REF. SPEC SECTION 02112)

1. NO LANDSCAPE TOPSOIL DRESSING GREATER THAN A 3" LAYER SHALL BE PERMITTED WITHIN THE DRIP LINE OF TREES. NO SOIL OR MULCH IS PERMITTED ON THE ROOT FLARE OF ANY TREE.

PRUNING TO PROVIDE CLEARANCE FOR STRUCTURES, VEHICULAR TRAFFIC, AND EQUIPMENT SHALL TAKE PLACE BEFORE CONSTRUCTION BEGINS BY CITY

3. ALL FINISHED PRUNING MUST BE DONE ACCORDING TO RECOGNIZED, APPROVED STANDARDS OF THE CITY OF SAN ANTONIO.

4. COVER SEVERED ROOTS AND TREE SIDE OF TRENCH WITH 8 MIL BLACK VISQUENE TO FULL DEPTH OF TRENCH AND 6" OVER TOP. STAPLE VISQUENE IN PLACE, BACKFILL AND COMPACT TRENCH WITH EXCAVATED SOIL, TO PROTECT

CORE AERATE AND DEEP ROOT FERTILIZE TREES BY PROBE AND WATER INJECTION OF DAVEY ARBOR GREEN FERTILIZER. REFER TO MANUFACTURER'S MAXIMUM RECOMMENDED RATES PER TREE CALIPER INCHES. INJECT 18"-24" DEEP 5'-0" O.C. THROUGHOUT DRIP-LINE OF TREE UNLESS OTHERWISE

CONTRACTOR SHALL MODIFY EXHAUST PIPES ON CONSTRUCTION EQUIPMENT AS NEEDED TO INSURE THAT TREE CROWNS ARE NOT DAMAGED FROM EXHAUST HEAT FROM VERTICAL EXHAUST PIPES ON TOP OF CONSTRUCTION


EQUIPMENT MUST NOT TOUCH UNDERSIDE OF TREE CROWNS.

CONTRACTOR SHALL BE RESPONSIBLE FOR PROVIDING ALL TREE WORK/REPAIR TO ANY DAMAGE TO EXISTING TREES DURING THE CONTRACT PERIOD. DAMAGE TO ANY EXISTING TREES SHALL BE REPORTED IMMEDIATELY TO THE OWNER'S REPRESENTATIVE. CONTRACTOR SHALL SUBMIT TO OWNER'S REPRESENTATIVE A WRITTEN PROGRAM OF CORRECTIVE PRUNING AND TREE CARE TO REPAIR DAMAGE WITH THE NAME OF A QUALIFIED URBAN FORESTER OR ARBORIST FOR OWNER'S APPROVAL


9. PLANS ARE DIAGRAMMATIC. CONTRACTOR IS RESPONSIBLE FOR FIELD VERIFICATION OF REQUIRED TREE FENCING LIMITS.


10. ALL EXISTING TREES, IN DESIGNATED PROTECTED AREAS, MUST BE PRUNED TO AVOID DAMAGE BY EQUIPMENT DURING CONSTRUCTION OPERATIONS

11. THESE NOTES ARE SUPPLEMENTARY TO SPECIFICATION SECTION 015639.

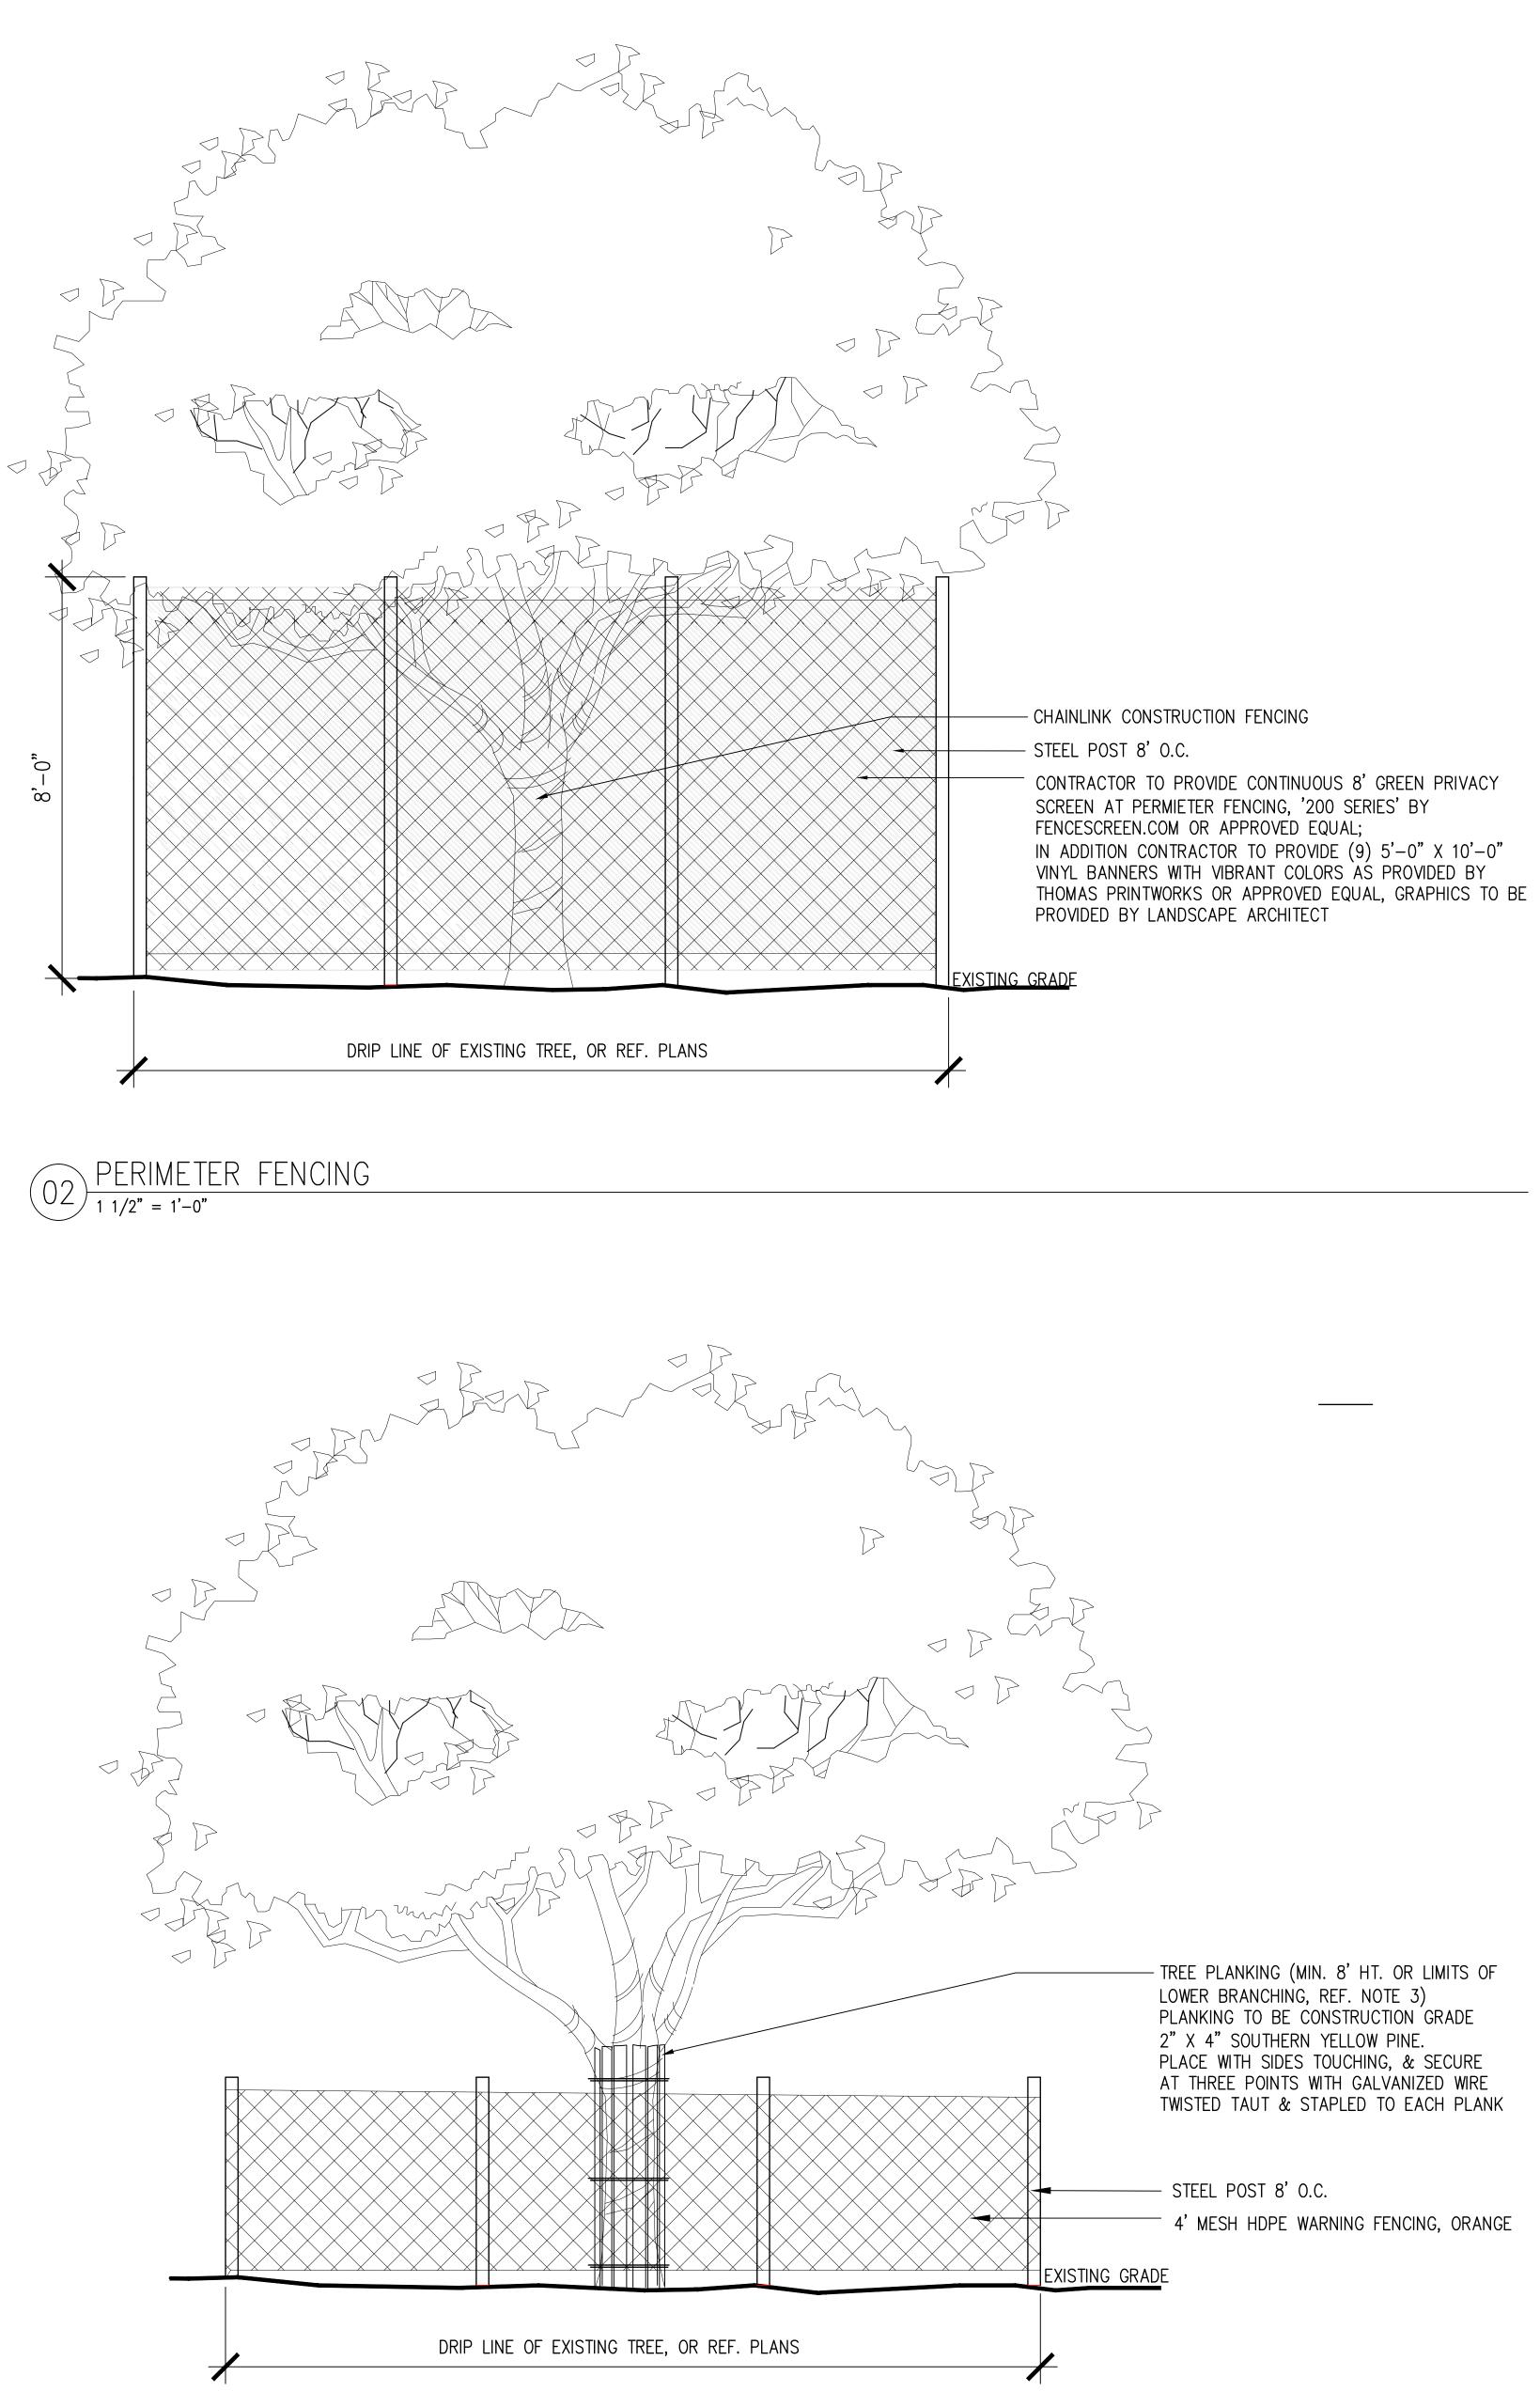



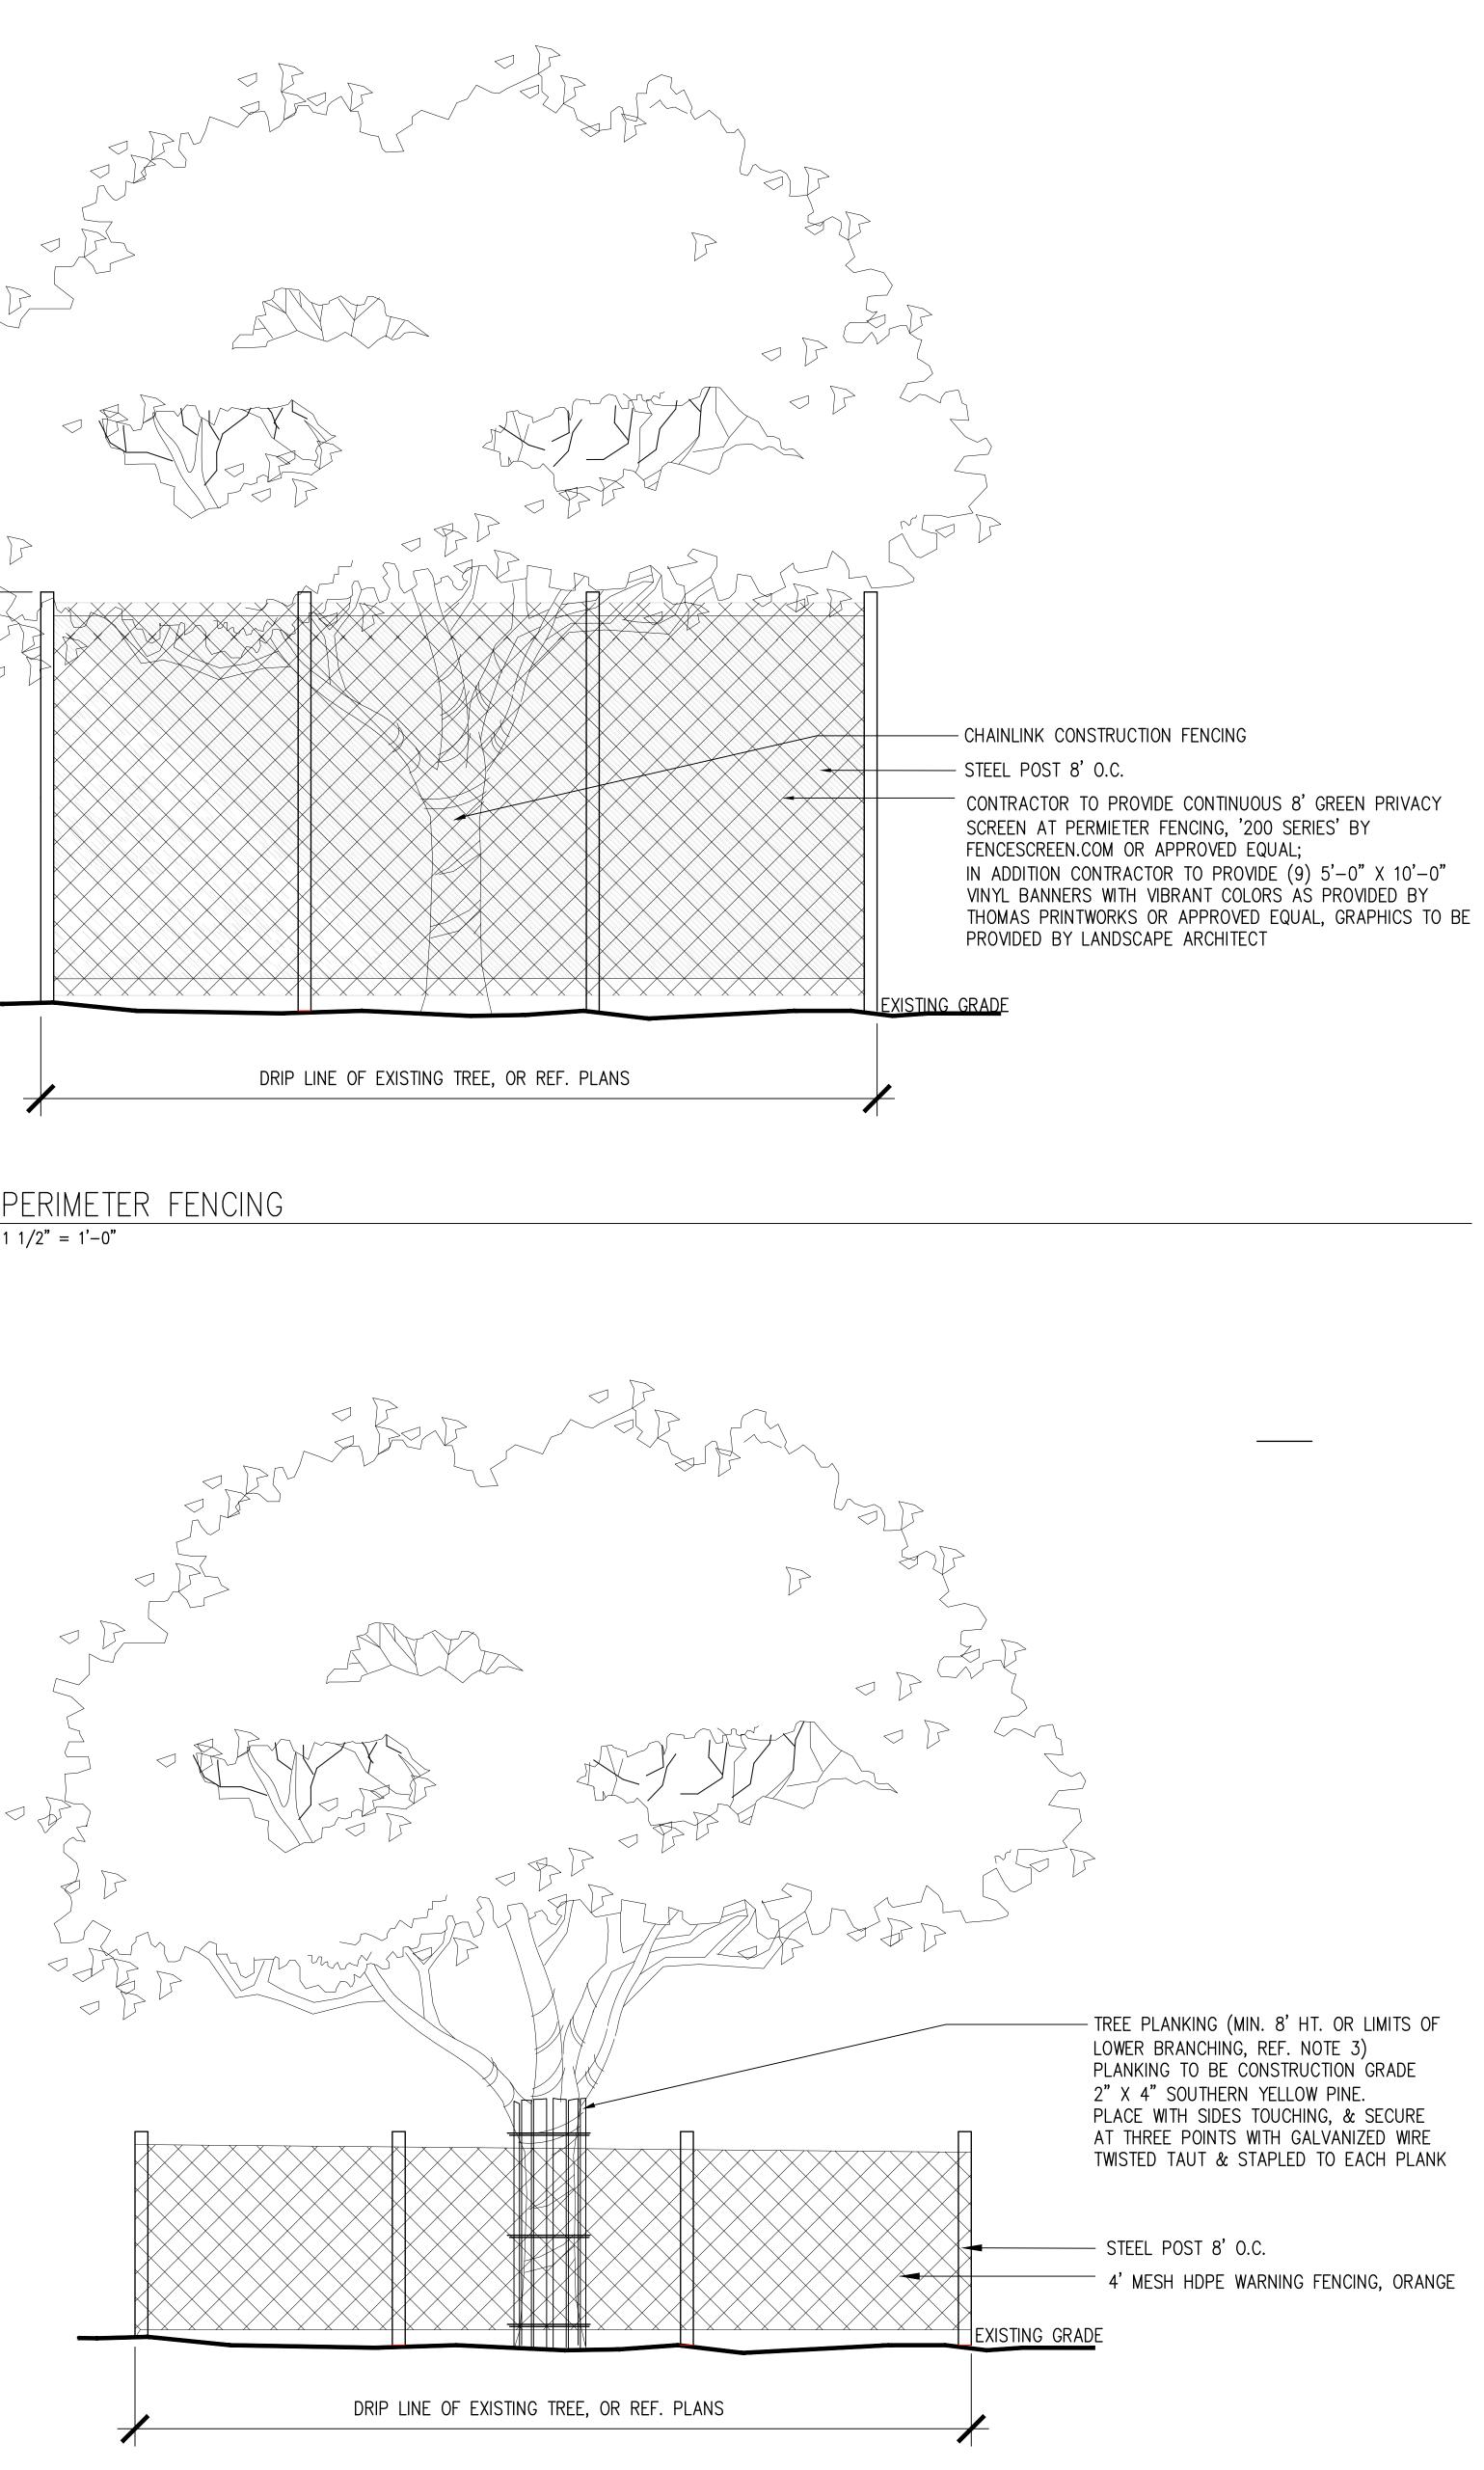

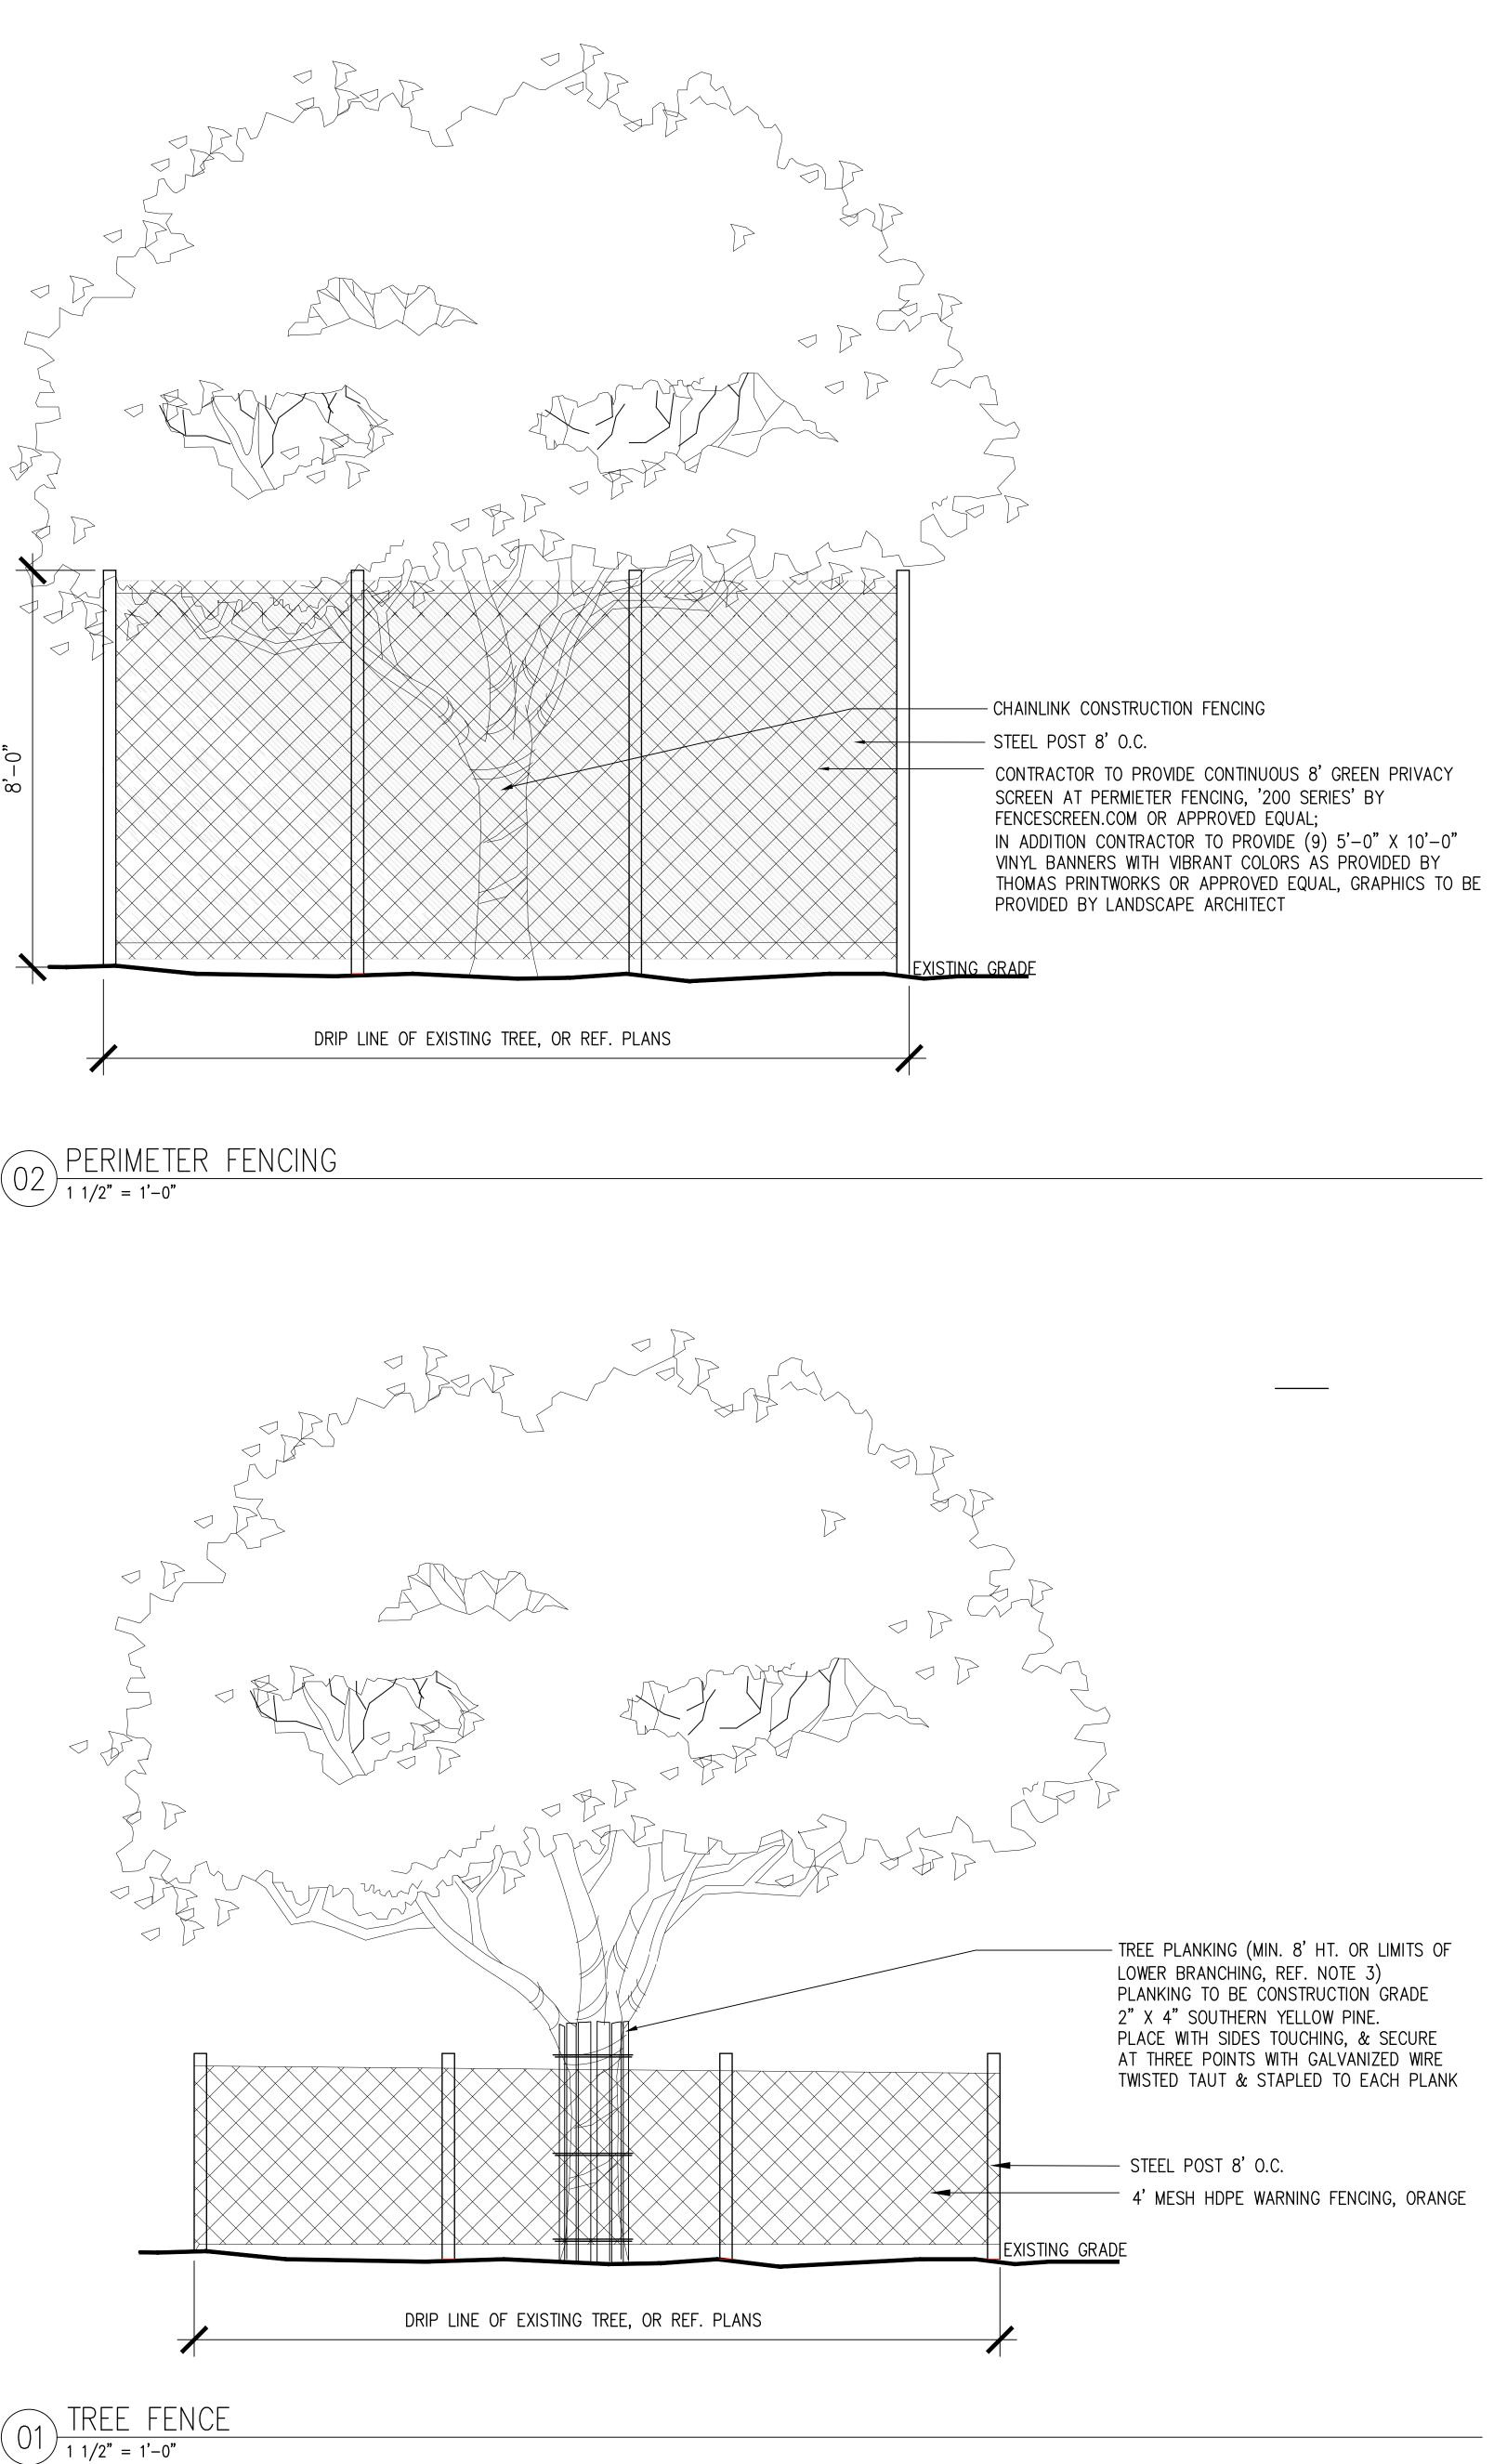

BRACKENRIDGE PARK

SAN ANTONIO, TX

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SAN ANTONIO TX, 78208

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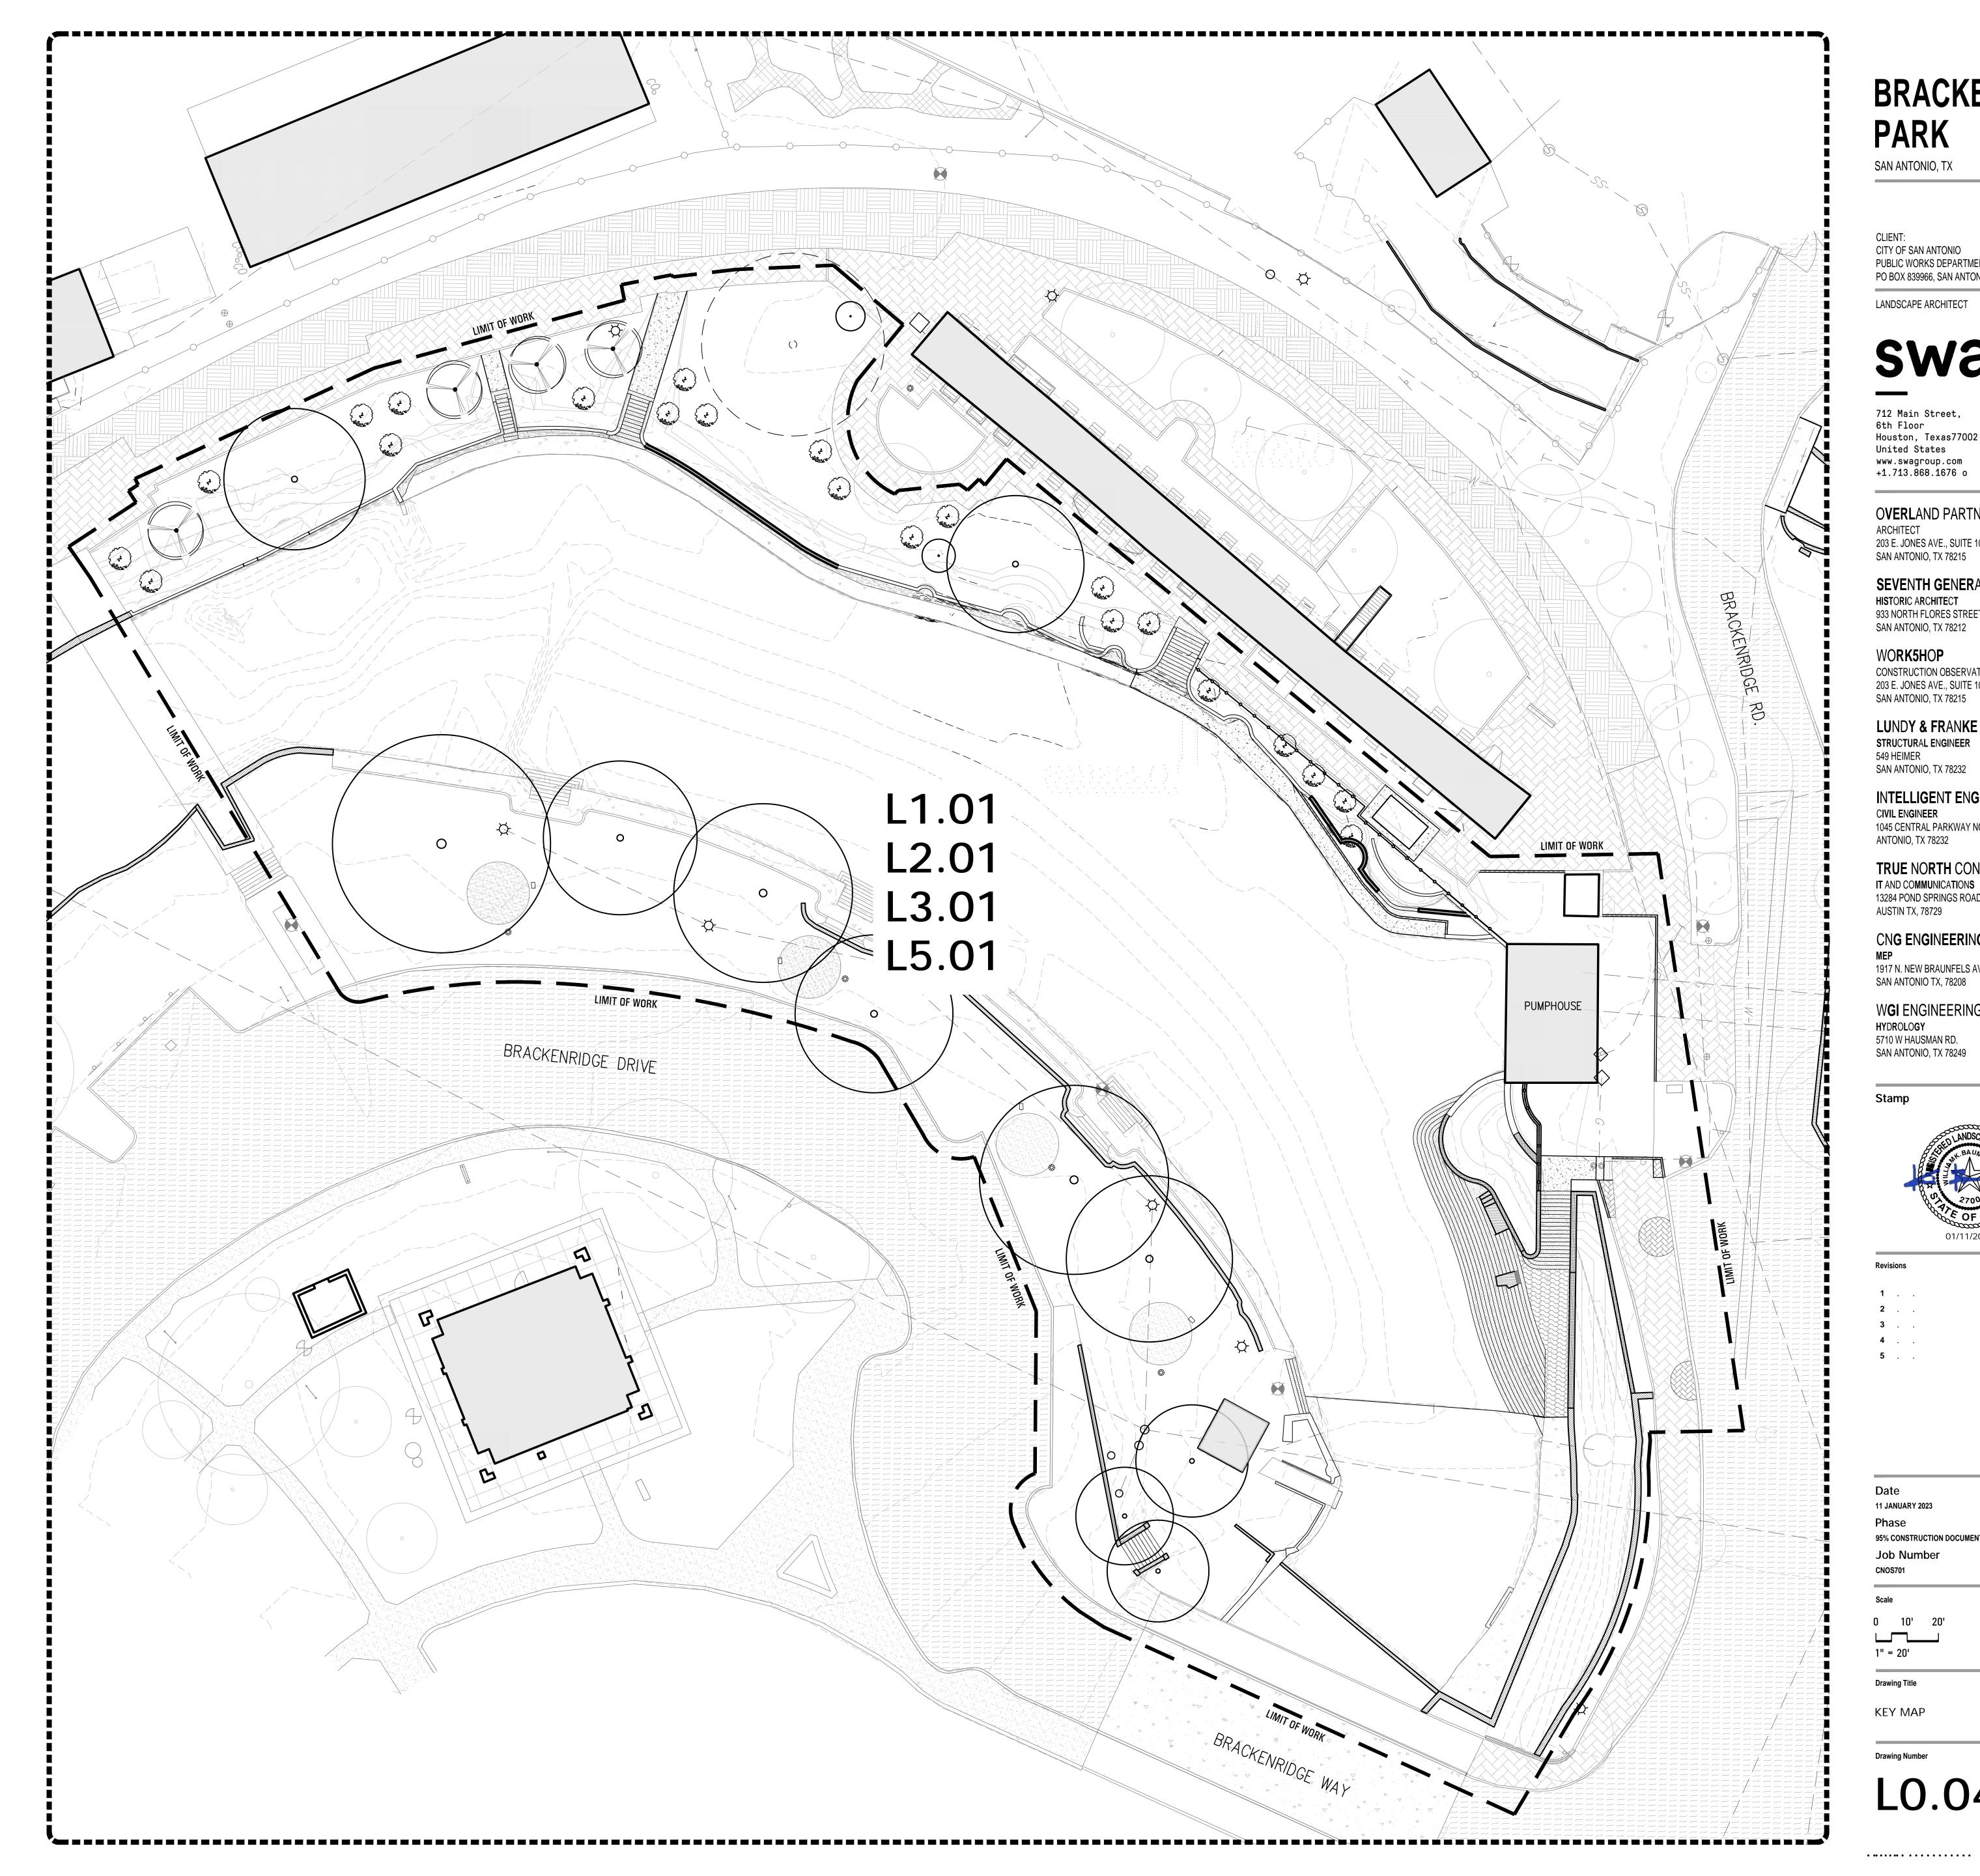
Date 11 JANUARY 2023 Phase 95% CONSTRUCTION DOCUMENTS Job Number CNOS701

Scale

Drawing Number

Drawing Title TREE PROTECTION AND DEMOLITION NOTES

L0.03





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MITIGATION SUMMARY

RIO 1 OVERLAY DISTRICT

REQUIRED MITIGATION

TOTAL FLOODPLAIN EXCESS / MITIGATION: **GRAND TOTAL EXCESS / MITIGATION REQUIRED:**

MITIGATION PROVIDED

MITIGATION PROPOSED AS PROPOSED PLANTINGS (PHASE 1) MITIGATION PROPOSED IN FUTURE PROJECT PHASES (PARK-WI MITIGATION PROVIDED AS PAYMENT (\$200 per Inch) MITIGATION BALANCE:

	san antonio - u E Canopy		loodplai	in Excluded)		
		TOTAL	PROJECT AREA		78,478	SF
	15%	CAN	NOPY REQUIRED		11,771.70	SF
CANOP	Y MET WITH PRI	ESERVED TREE	S - REFERENCE	TP SERIES		
άтΥ.	SHADE VALUE	PERCENI	SQFT	SPECIES		
4	1,200	 100%	4,800	(4) Pecan		╞
16	875	100%	14,000	(3) Live Oak, (1) Hackberry, (1) Eve's Necklace, (2) Cedar Em. (9) Bald Cypress		\vdash
2	550	100%	1,100	(2) Mesquite		\square
2	275	100%	550	(2) Mexican Buckeye		\square
24						
		TOTAL PRESI	ERVED CANOPY		20,450	SF
		TOTAL PRESI	ERVED CANOPY		26.1%	1
CANOP	Y MET WITH PRO	OPOSED TREE I	PLANTINGS - RE	FERENCE L SERIES		
ату.	SHADE VALUE	PERCENI	SQFT	SPECIES		
4	875	90%	3,150.00	(4) Live Oak		┢
11	275	90%	2,722.50	(3) Possumhaw Holly, (3) TX. Mountain Laurel, (5) Yaupon Holly		┢
I		TOTAL PROF	POSED CANOPY		5,873	SF
		TOTAL PROF	POSED CANOPY		7.5%	1
		TOTAL CAN	OPY PROVIDED		26,323	SF
		TOTAL CAN	OPY PROVIDED		33.5%	, 0
	PERCE	NT INCREASE FRO	om preserved		59.6%	D

NOTES:

1. TREE 101 TO BE RELOCATED WITHIN SCOPE OF WORK AS INDICATED ON PLAN 2. ALL OTHER TREES TO BE RELOCATED OUTSIDE LIMIT OF WORK, BUT WITHIN GREATER BRACKENRIDGE PARK

CITY OF SAN ANTONIO - UDC V-5-35-523

Floodplain Tree Preservation Inventory

				SMALL SPECIES TREES**				LARGE SPECIES TREES*						
TREE #	TAG #	SPECIES	DBH	SIGNIFICANT PRESERVED	SIGNIFICANT REMOVED	HERITAGE PRESERVED	HERITAGE REMOVED (1:1)	SIGNIFICANT PRESERVED	SIGNIFICANT REMOVED	HERITAGE PRESERVED	HERITAGE REMOVED (3:1)	HERITAGE REMOVED (1:1)	PROTECTED CAL. INCHES EXEMPT	COMMENTS
92	2229	Oak	7					7						
93	2234	Bald Cypress	19											Dead; TO BE REMOVED
94 95	2339 2334	Chinese Tallow Oak	12 32								32		12	Invasive Species; TO BE REMOVED
96	2338	Oak	34							34				
97	2310	Oak	22						22					
98	2364 2335	Oak	18						18					
99 00	6006 (2306)	Oak Oak	16 37						16		37			
01	2324	Oak	44							44				TO BE RELOCATED
02	2319	Cedar Elm	18						18					
03 04	2328 6007 (602)	Bald Cypress Pecan	20 8					8					20	Outside LOW; PRESERVED, Not Countee
)4)5	2366	Bald Cypress	33					0		33				
06	2358	Cypress	23						23					
)7	2364	Black Walnut	18						18					
08 09	2392 2325	Black Walnut	22 10					10	22					TO BE RELOCATED; Multi-Trunk
11	3026	Crepe Myrtle Yaupon	3		3			10						TO BE RELOCATED, Multi-ITUNK
12	2372	Crepe Myrtle	16					16						TO BE RELOCATED; Multi-Trunk
13	2375	Pecan	20					20						TO BE RELOCATED; Multi-Trunk
16 17	2359 2314	Pecan Pecan	23.5					23.5		24				
17 18	2314 2387	Crepe Myrtle	24							24			1	
19	2311	Crepe Myrtle	15						15					Multi-trunk
20	2344	Crepe Myrtle	23											Dead; Multi-trunk; TO BE REMOVED
21	2371	Crepe Myrtle	25										25	Dead; Multi-trunk; TO BE REMOVED
22 23	2383 2342	Pecan Cypress	22 40						22	40				
.23	2388	Bald Cypress	40							40				
25	2343	Crepe Myrtle	27								27			Multi-trunk
26	2398	Bald Cypress	38							38				
27 28	2378 2336	Crepe Myrtle	9						9				22	Dood: Arborist Possemmanded for Pome
28 29	2336	Crepe Myrtle Bald Cypress	22 43							43			22	Dead; Arborist Recommended for Remo
30	2337	Bald Cypress	37							37				
31	2315	Hackberry	25				25							Multi-trunk
.32	2400	Crepe Myrtle	17						17					Multi-trunk
.33 .34	2320 6008 (2376)	Bald Cypress Oak	53 16						16	53				
134 135	6009 (2307)	Oak	15						15					
L36	6010 (603)	Oak	20						20					
.37	6011 (2305)	Cedar Elm	17						17					
.38	6012 (2309)	Cedar Elm	16						16		20			
.39 .40	2385 2399	Pecan Pecan	26 24								26 24			
.41	2354	Bald Cypress	27								27			
.42	2316	Pecan	20								20			
.43	2318	Cedar Elm	12						12					
.44 .15	2373 2390	Eve's Necklace Crepe Myrtle	<u> </u>					8	19					TO BE RELOCATED
35	10427	Anaqua	8					-	8					Multi-Tunk
36	10426	Oak	6						6					
37	10425	Huisache	5		5									Cluster
38 39	10407 10424	Yaupon Holly Mesquite	5		2			5						TO BE RELOCATED
40	10424	Crepe Myrtle	3		2				3					
40 41	10406	Yaupon Holly	2					2						TO BE RELOCATED
42	10405	Elm	1						1					
43	10404	Elm	4					4						TO BE RELOCATED
.44 .45	10403 10402	Hackberry Hackberry	2		2									
.45 .46	10402	Elm	2		-+			2					1	TO BE RELOCATED
247	10423	Cypress	3					3						TO BE RELOCATED
248	10422	Cypress	3					3						TO BE RELOCATED
249	10418	Chinaberry	4						л				4	Invasive Species;TO BE REMOVED
250 251	10420 10411	Oak Chinaberry	<u>4</u> 2						4				2	Invasive Species; TO BE REMOVED
.51 .52	10411	Chinaberry	4											Invasive Species; TO BE REMOVED
53	10415	Pecan	4						4					CLUSTER
54	10400	Yaupon Holly	5					5						TO BE RELOCATED
55 56	3025	Buckeye	4					4 E						TO BE RELOCATED
56 57	3023 3024	Buckeye Buckeye	5					5 4						TO BE RELOCATED TO BE RELOCATED
66	10408	Mesquite	4	4										TO BE RELOCATED
67	10409	Buckeye	4					4						TO BE RELOCATED
68	10410	Mesquite	4.5	4.5										TO BE RELOCATED
69 70	10411	Buckeye	2					2						TO BE RELOCATED
70 71	10412	Hackberry	4	4	8									TO BE RELOCATED; Twin
71 72	10413 10414	Hackberry Hackberry	8		3									Cluster
73	2335	Crepe Myrtle	6						6				1	
.75 :75	3026	Yaupon Holly	2					2					1	TO BE RELOCATED
		······································		+	27		25	135.5	347	419	193	0	131	· · · · · · · · · · · · · · · · · · ·

Preserved- Tree to remain that meets root protection zone requirements described in section 35-523 of the UDC. *Mitigation 1:1 for significant trees below minimum preservation requirements; 3:1 for heritage trees below 100% preservation

** Small species: Condalia, Redbud, Tx. Mountain Laurel, Tx. Persimmon, Hawthorn, Possumhaw - these are mitigated at 1:1 for all small trees regardless of size within the Floodplain and heritage trees are mitigated at 1:1

** Ashe Juniper, Huisache, Mesquite, Arizona Ash, Hackberry protected regardless of size in the Floodplain and mitigated at 1:1 for heritage trees (12" DBH)

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PROJECT SITE WITHIN CRAG AREA

NOTES NOTES

BRACKENRIDGE PARK SAN ANTONIO, TX

CLIENT: CITY OF SAN ANTONIO PUBLIC WORKS DEPARTMENT (TCI) PO BOX 839966, SAN ANTONIO TX 78283-3966

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Revisions

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Drawing Number

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Date 1 JANUARY 2023 Phase 5% CONSTRUCTION DOCUMENTS Job Number CNOS701	
Scale	North
8' 16' / ₁₆ " = 1'-0"	
Drawing Title	
TREE PROTECTION AN MITIGATION SUMMAR	

TREE REMOVAL KEY			
SYMBOL	DESCRIPTION		
•	TREE TO BE PRESERVED		
	TREE TO BE REMOVED TO BE REMOVED UNDER HISTORIAN OVERSIGHT REFER TO TREE REMOVAL NOTES		
	TREE TO BE RELOCATED UNDER HISTORIAN OVERSIGHT; REF. NOTES		
	LOCATION OF MOVED TREE; INSTALL UNDER HISTORIAN OVERSIGHT; REF. NOTES		

NOTES: 1. TREE 101 TO BE RELOCATED WITHIN SCOPE OF WORK AS INDICATED ON PLAN
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BRACKENRIDGE PARK

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Date 11 JANUARY 2023 Phase 95% CONSTRUCTION DOCUMENTS Job Number CNOS701	
Scale	North
) 8' 16' 1/ ₁₆ " = 1'-0"	
Drawing Title TREE PROTECTION AN MITIGATION PLAN	D
Drawing Number	

	HISTORIC STRUCTURES
	PROTECT TO IN PLACE
SYMBOL	DESCRIPTION
(H01)	STONE COBBLE WALL; CONTRACTOR TO CONFIRM EXTENTS IN FIELD WITH LANDSCAPE ARCHITECT PRIOR TO COMMENCEMENT OF DEMOLITION WORK
(H02)	CONCRETE STAIRS AND STONE COBBLE STAIR WALLS
(ноз)	PUMP HOUSE
(H04)	STONE MASONRY PUMP HOUSE CHEEK WALLS
(H05)	STONE "BENCH" AT LARGE LAMBERT BEACH STAIR; CONTRACTOR TO CONFIRM EXTENTS IN FIELD WITH LANDSCAPE ARCHITECT PRIOR TO COMMENCEMENT OF DEMOLITION WORK
(H06)	ORIGINAL STONE STEPS AND LANDING AT LARGE LAMBERT BEACH STAIR; CONTRACTOR TO CONFIRM EXTENTS IN FIELD WITH LANDSCAPE ARCHITECT PRIOR TO COMMENCEMENT OF DEMOLITION WORK
(H06)	CONCRETE RIVER CHANNEL WALK AND SUBMERGED WALLS
(H07)	SUBMERGED CONCRETE STEPS ("FLOATING STAIRS") TO BE PROTECTED IN PLACE

	DEMOLITION SCHEDULE
SYMBOL	DESCRIPTION
	NOT USED
02	REMOVE CONCRETE CURB; CONCRETE TO BE SAWCUT 12 IN AWAY FROM HISTORIC STRUCTURE. REMAINING 12 IN OF CONCRETE ADJACENT TO HISTORIC STRUCTURE TO BE REMOVED BY HAND
03	REMOVE CONCRETE UNIT PAVERS AND ASSOCIATED CONCRETE SUBBASE; PAVERS TO BE CLEANED AND STORED ON SITE FOR USE IN REPLACEMENT OF DAMAGED PAVERS DURING CONSTRUCTION
04	REMOVE CONCRETE STEP; SAW CUTS TO BE CLEAN AND REMAINING EDGES ORTHOGONAL AND VISUALLY PLEASING
(D05)	REMOVE CONCRETE PAVING; ENSURE SAW CUTS ARE CLEAN AND ORTHOGONAL; EXTREME CARE TO BE EXERCISED ADJACENT TO EXISTING STRUCTURES AND HISTORIC RESOURCES
006	REMOVE STONE CLAD WALL; PORTION INDICATED TO BE PROTECTED IN PLACE; CONTRACTOR TO CONFIRM EXTENTS OF DEMOLITION IN FIELD WITH LANDSCAPE ARCHITECT PRIOR TO COMMENCING WORK
007	SELECTIVELY DEMOLISH LARGE STONE STAIR; HISTORIC PORTIONS INDICATED TO BE PROTECTED IN PLACE; STONE FROM WALL TO BE SALVAGED, CLEANED AND STORED ON SITE FOR USE IN RECONSTRUCTION OF STONE WALLS
008	CONCRETE PAVING AT RIVER CHANNEL WALK TO BE REMOVED; CONTRACTOR TO EXERCISE EXTREME CARE IN DEMOLITION AS TO NOT DAMAGE SUBMERGED STONE RIVER CHANNEL WALL BELOW
09	WET WELL SUMP, VAULT, AND WATER PUMP TO BE REMOVED
<u>(D10)</u>	LITTER RECEPTACLE TO BE REMOVED AND TRANSFERRED TO THE CITY OF SAN ANTONIO PARKS DEPARTMENT
(D11)	UTILITY VAULT, METER AND CONDUIT TO BE REMOVED REFER TO CIVIL
(D12)	INFORMATION SIGNAGE TO BE REMOVED AND TRANSFERRED TO THE CITY OF SAN ANTONIO PARKS DEPARTMENT
(D13)	CHAIN LINK FENCE TO BE REMOVED

TREE REMOVAL KEY

SYMBOL	DESCRIPTION
	TREE TO BE PRESERVED
•	TREE TO BE REMOVED
	TREE TO BE RELOCATED

REFER TO TREE MITIGATION PLANS AND SCHEDULES



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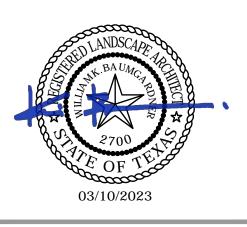
TRUE NORTH CONSULTING GROUP IT AND COMMUNICATIONS 13284 POND SPRINGS ROAD, STE. 304 AUSTIN TX, 78729

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Stamp



Revisions

ADDENDUM 01 03/10/2023

Date 11 JANUARY 2023 Phase 95% CONSTRUCTION DOCUMENTS Job Number	
CNOS701	
Scale	North
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Drawing Title	
DEMOLITION PLAN	
Drawing Number	
L2.01	

MOCK	K-UP SCHEDULE			
KEY	DESCRIPTION	MOCK-UP SIZE	APPROVALS REQUIRED	REMARK
P01	STONE COBBLE PAVING AT LARGE STAIR LANDING	5' x 5'	LANDSCAPE ARCHITECT, CLIENT GROUP, REGULATORY AGENCIES	LIMESTONE PAVING AND MORTAR; PROVIDE MORTAR SAMPLES
P04	PORTLAND GRAY PEDESTRIAN RATED CONCRETE PAVING	5' X 5'	LANDSCAPE ARCHITECT, CLIENT GROUP, REGULATORY AGENCIES	PROVIDE MOCK UP WITH FINISH, AS WELL AS AN EXPANSION JOINT AND CONTROL JOINT
P05	INTEGRAL COLOR PEDESTRIAN RATED CONCRETE PAVING	5' X 5'	LANDSCAPE ARCHITECT, CLIENT GROUP	CONTRACTOR TO DIVIDE INTEGRAL COLOR MOCK UP INTO QUARTERS AND PROVIDE THE FOLLOWING TOP CAST FINISHES: 03 LIGHT VIOLET, 05 POWDER BLUE VIOLET, AND 15 YELLOW
W02A	HISTORIC WALL RECONSTRUCTION A	6'H X 6'W	LANDSCAPE ARCHITECT, CLIENT GROUP, REGULATORY AGENCIES	STONE AND HISTORIC MORTAR
W02B	HISTORIC WALL RECONSTRUCTION B	6'H X 6'W	LANDSCAPE ARCHITECT, CLIENT GROUP, REGULATORY AGENCIES	STONE AND HISTORIC MORTAR
W03	NEW STONE WALL WITH COBBLE AND CONCRETE REINFORCEMENT	6'H X 6'W	LANDSCAPE ARCHITECT, CLIENT GROUP, REGULATORY AGENCIES	STONE AND LATICRETE MORTAR
S02	NEW STONE COBBLE STAIRS ON CONCRETE FOUNDATION	2 LANDINGS AND 1 RISER AT 5' WIDE	LANDSCAPE ARCHITECT, CLIENT GROUP, REGULATORY AGENCIES	STONE AND LATICRETE MORTAR

PAVI	PAVING SCHEDULE (P)								
SYMBOL	KEY	DESCRIPTION	SUPPLIER	MATERIAL	SIZE	COLOR	FINISH	REMARK	DETAIL
	P01	STONE COBBLE PAVING AT LARGE STAIR LANDING	ALAMO STONE OR APPROVED EQUAL; LATICRETE 3701 OR APPROVED EQUAL	LIMESTONE	_	CHAMPAGNE / WEST TEXAS CREAM	COBBLE FINISH TO APPROXIMATE HISTORIC STONE; REFER TO WALL DETAILS	_	02, 03/L4.05
	P02	STONE COBBLE TRANSITION AT LARGE STAIR HISTORIC "BENCH"	ALAMO STONE OR APPROVED EQUAL; LATICRETE 3701 OR APPROVED EQUAL	LIMESTONE	_	CHAMPAGNE / WEST TEXAS CREAM	COBBLE FINISH TO APPROXIMATE HISTORIC STONE; REFER TO WALL DETAILS	_	06/L4.03
	P03	CONCRETE UNIT PAVERS ON STABILIZED SAND BED	_	EXISTING SALVAGED CONCRETE UNIT PAVERS	_	_	_	IF SALVAGED PAVERS ARE NOT FEASIBLE, REPLACEMENT TO MATCH EXISTING	04/L4.01
	P04	PORTLAND GRAY PEDESTRIAN RATED CONCRETE PAVING	_	CONCRETE	_	NATURAL GRAY	Medium Broom Finish	REFER TO CIVIL FOR REINFORCEMENT, THICKNESS, AND SUBBASE DESIGN	01/L4.01
	P05	INTEGRAL COLOR PEDESTRIAN RATED CONCRETE PAVING	SIKA/SCOFIELD; TOPCAST	INTEGRAL COLOR CONCRETE	_	U-22 SALT MARSH GRAY	TOPCAST SURFACE RETARDER; EXTENT OF RETARDANT TO BE DETERMINED AT MOCK UP REVIEW	REFER TO CIVIL FOR REINFORCEMENT, THICKNESS, AND SUBBASE DESIGN	01/L4.01
	P06	PORTLAND GRAY CONCRETE CURB	_	CONCRETE	_	NATURAL GRAY	_	_	REF. CIVIL

AMENITY SCHEDULE (A)								
KEY	DESCRIPTION	MATERIAL	SUPPLIER	SIZE	COLOR	FINISH	REMARK	DETAIL
A01	BLACK VINYL COATED CHAIN LINK FENCE	GALVANIZED STEEL	BROSPER OR EQUAL	2" MESH SIZE; 42" HIGH WITH 11 GAUGE WIRE	BLACK	_	_	_
A02	LIFT STATION	_	_	_	_	_	_	REF. HYDROLOGY

WAL	WALL SCHEDULE (W)								
KEY	DESCRIPTION	MATERIAL	SUPPLIER	SIZE	COLOR	FINISH	REMARK	DETAIL	
W01	HISTORIC REHABILITATED WALL	STONE SALVAGED FROM SITE OR STOCKPILED LOCAL STONE APPEARANCE TO MATCH EXISTING ADJACENT HISTORIC STRUCTURES	EXISTING AND APPROVED HISTORIC STONE SALVAGE YARD	GENERAL SIZE AND APPEARANCE OF STONE TO MATCH ADJACENT EXTANT HISTORIC WALLS	NATURAL; MATCH IN-KIND AND APPEARANCE TO HISTORIC STONE	MATCH FINISH TO HISTORIC STONE; REF. STONE SPECIFICATIONS FOR HISTORIC MORTAR	REF. HISTORIC STONE SPECIFICATIONS	REF. STONE SPECS	
W02A	HISTORIC WALL RECONSTRUCTION A	STONE SALVAGED FROM SITE OR STOCKPILED LOCAL STONE APPEARANCE TO MATCH EXISTING ADJACENT HISTORIC STRUCTURES	EXISTING AND APPROVED HISTORIC STONE SALVAGE YARD	GENERAL SIZE AND APPEARANCE OF STONE TO MATCH ADJACENT EXTANT HISTORIC WALLS	NATURAL; MATCH IN-KIND AND APPEARANCE TO HISTORIC STONE	MATCH FINISH TO HISTORIC STONE; REF. STONE SPECIFICATIONS FOR HISTORIC MORTAR	REF. HISTORIC STONE SPECIFICATIONS	01/L4.04	
W02B	HISTORIC WALL RECONSTRUCTION B	STONE SALVAGED FROM SITE OR STOCKPILED LOCAL STONE APPEARANCE TO MATCH EXISTING ADJACENT HISTORIC STRUCTURES	EXISTING AND APPROVED HISTORIC STONE SALVAGE YARD	GENERAL SIZE AND APPEARANCE OF STONE TO MATCH ADJACENT EXTANT HISTORIC WALLS	NATURAL; MATCH IN-KIND AND APPEARANCE TO HISTORIC STONE	MATCH FINISH TO HISTORIC STONE; REF. STONE SPECIFICATIONS FOR HISTORIC MORTAR	REF. HISTORIC STONE SPECIFICATIONS	02/L4.04	
W03	NEW STONE WALL WITH COBBLE AND CONCRETE REINFORCEMENT	LIMESTONE	ALAMO STONE OR APPROVED EQUAL; LATICRETE 3701 OR APPROVED EQUAL	NEW STONE TO BE SAME SIZE RANGE AS HISTORIC WALL MASONRY	CHAMPAGNE / WEST TEXAS CREAM	Finish to Match Adjacent Historic Stone; Refer to Details	_	03/L4.04	
W04	REHABILITATED HISTORIC STONE STEPS AT LARGE LAMBERT BEACH STAIR	STONE SALVAGED FROM SITE OR STOCKPILED LOCAL STONE APPEARANCE TO MATCH EXISTING ADJACENT HISTORIC STRUCTURES	EXISTING AND APPROVED HISTORIC STONE SALVAGE YARD	GENERAL SIZE AND APPEARANCE OF STONE TO MATCH ADJACENT EXTANT HISTORIC WALLS	NATURAL; MATCH IN-KIND AND APPEARANCE TO HISTORIC STONE	MATCH FINISH TO HISTORIC STONE; REF. STONE SPECIFICATIONS FOR HISTORIC MORTAR	REF. HISTORIC STONE SPECIFICATIONS	04/L4.03	
W05	REHABILITATED HISTORIC STONE "BENCH" AT LAMBERT BEACH STONE STAIR	STONE SALVAGED FROM SITE OR STOCKPILED LOCAL STONE APPEARANCE TO MATCH EXISTING ADJACENT HISTORIC STRUCTURES	EXISTING AND APPROVED HISTORIC STONE SALVAGE YARD	GENERAL SIZE AND APPEARANCE OF STONE TO MATCH ADJACENT EXTANT HISTORIC WALLS	NATURAL; MATCH IN-KIND AND APPEARANCE TO HISTORIC STONE	MATCH FINISH TO HISTORIC STONE; REF. STONE SPECIFICATIONS FOR HISTORIC MORTAR	REF. HISTORIC STONE SPECIFICATIONS	05/L4.03	

STAIR SCHEDULE (S)								
KEY	DESCRIPTION	MATERIAL	SUPPLIER	SIZE	COLOR	FINISH	REMARK	DETAIL
S01 REHABILITATED HISTORIC CONCRETE STAIRS AND STONE COBBLE STAIR WALLS AF		STONE SALVAGED FROM SITE OR STOCKPILED LOCAL STONE APPEARANCE TO MATCH EXISTING ADJACENT HISTORIC STRUCTURES	EXISTING AND APPROVED HISTORIC STONE SALVAGE YARD	GENERAL SIZE AND APPEARANCE OF STONE TO MATCH ADJACENT EXTANT HISTORIC WALLS	NATURAL; MATCH IN-KIND AND APPEARANCE TO HISTORIC STONE	MATCH IN FINISH TO HISTORIC STONE; REF. STONE SPECIFICATIONS FOR HISTORIC MORTAR	REF. HISTORIC STONE SPECIFICATIONS	REF. STONE SPECS
S02	NEW STONE COBBLE STAIRS ON CONCRETE FOUNDATION	LIMESTONE	ALAMO STONE OR APPROVED EQUAL; LATICRETE 3701 OR APPROVED EQUAL	_	CHAMPAGNE / WEST TEXAS CREAM	FINISH TO MATCH ADJACENT HISTORIC STONE; REFER TO DETAILS	_	01/L4.05
S03	PORTLAND GRAY CONCRETE STAIRS	CONCRETE	_	_	NATURAL GRAY	_	-	05/L4.01
S04	REHABILITATED HISTORIC MASONRY STAIRS	STONE SALVAGED FROM SITE OR STOCKPILED LOCAL STONE APPEARANCE TO MATCH EXISTING ADJACENT HISTORIC STRUCTURES	EXISTING AND APPROVED HISTORIC STONE SALVAGE YARD	GENERAL SIZE AND APPEARANCE OF STONE TO MATCH ADJACENT EXTANT HISTORIC WALLS	NATURAL; MATCH IN-KIND AND APPEARANCE TO HISTORIC STONE	MATCH IN FINISH TO HISTORIC STONE; REF. STONE SPECIFICATIONS FOR HISTORIC MORTAR	REF. HISTORIC STONE SPECIFICATIONS	REF. STONE SPECS

- 1. CONTRACTOR TO COORDINATE AN ON SITE MEETING BETWEEN CLIENT AND DESIGN TEAM PRIOR TO THE COMMENCE OF WORK. MEETING TO - EXTENTS AND METHODS OF DEMOLITION AND DISMANTLING
- THE APPLICATION OF APPROPRIATE SPECIFICATIONS TO EACH AREA AND STRUCTURE 2. ALL NEW CONCRETE PAVING AND FOUNDATIONS ADJACENT TO HISTORIC STRUCTURES TO HAVE AN EXPANSION JOINT BETWEEN THE
- 3. ALL HISTORIC AND EXISTING STRUCTURES TO BE CLEANED; REFER TO SPECIFICATIONS FOR ADDITIONAL INFORMATION
- 4. CONTRACTOR AND DESIGN TEAM TO ASSESS CONDITION OF STRUCTURES BELOW WATER LINE DURING DEWATERING CONTRACTOR TO PROVIDE UNIT COSTS FOR THE REPAIR OF HISTORIC STRUCTURES THAT INCLUDE: - CONCRETE RIVER CHANNEL BOTTOM
 - CONCRETE RIVER CHANNEL WALLS - MASONRY RIVER CHANNEL WALLS

NOTES:

CONFIRM THE FOLLOWING:

SPECIFICATIONS

STRUCTURE AND THE NEW CONCRETE

– MASONRY WEIR WALL

- CONCRETE WALL AT "KIDDIE" POOL EDGE
- MISC MASONRY SITE WALLS 5. REFER TO SPECIFICATIONS FOR GUIDELINES ON REHABILITATION OF HISTORIC STRUCTURES
- 6. REFER TO MOCK UP SCHEDULE FOR LIST OF REQUIRED MOCKUPS 7. REFER GENERAL CONSTRUCTION NOTES ON SHEET LO.02 AND TREE PROTECTION NOTES ON SHEET LO.03 PRIOR TO ANY SITE WORK 8. ALL CONCRETE FLATWORK TO REFERENCE LANDSCAPE AND CIVIL SPECIFICATIONS. ALL STRUCTURAL CONCRETE TO REFERENCE STRUCTURAL

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Revisions

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Date 11 JANUARY 2023 Phase 95% CONSTRUCTION DOCUMENTS Job Number CNOS701

Scale

Drawing Title LAYOUT AND MATERIALS SCHEDULE

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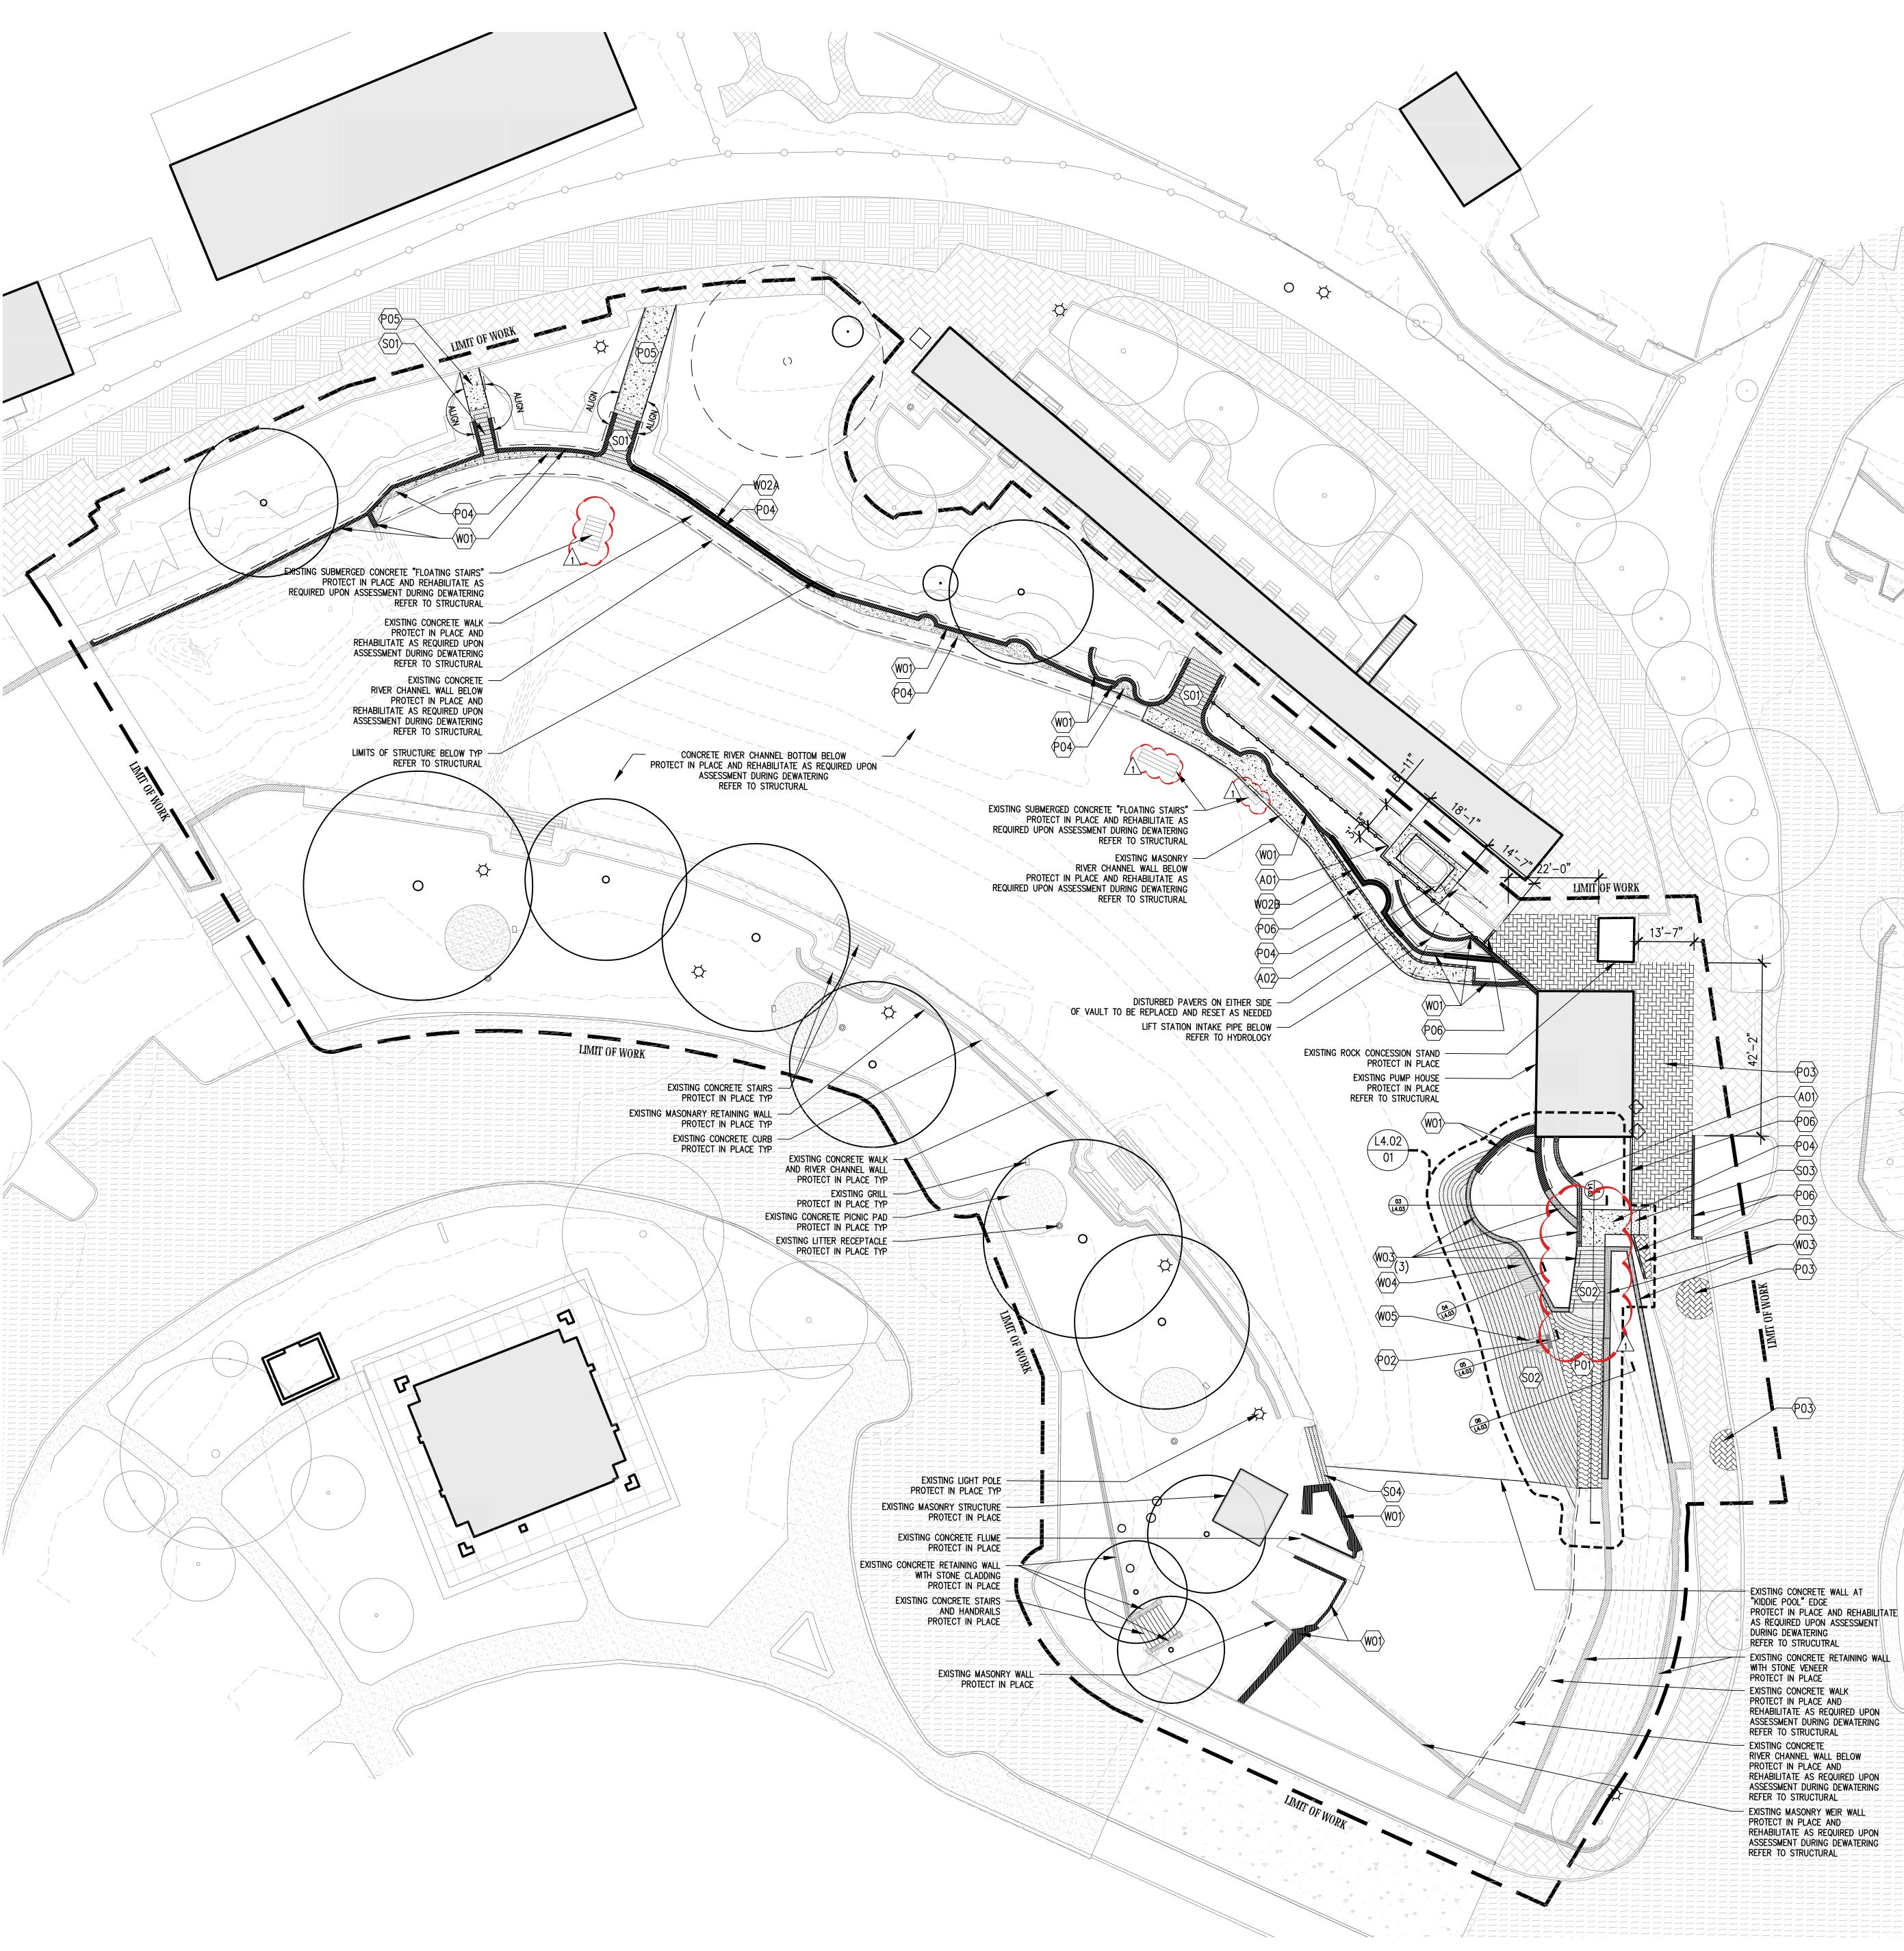
Drawing Number

PAVING SCHEDULE (P)					
SYMBOL	KEY	DESCRIPTION			
	P01	STONE COBBLE PAVING AT LARGE STAIR LANDING			
	P02	STONE COBBLE TRANSITION AT LARGE STAIR HISTORIC "BENCH"			
	P03	CONCRETE UNIT PAVERS ON STABILIZED SAND BED			
	P04	PORTLAND GRAY PEDESTRIAN RATED CONCRETE PAVING			
	P05	INTEGRAL COLOR PEDESTRIAN RATED CONCRETE PAVING			
	P06	PORTLAND GRAY CONCRETE CURB			

AMENITY SCHEDULE (A)					
KEY	DESCRIPTION				
A01	BLACK VINYL COATED CHAIN LINK FENCE				
A02	LIFT STATION				

WALL SCHEDULE (W)						
KEY	DESCRIPTION					
W01	HISTORIC REHABILITATED WALL					
W02A	HISTORIC WALL RECONSTRUCTION A					
W02B	HISTORIC WALL RECONSTRUCTION B					
W03	NEW STONE WALL WITH COBBLE AND CONCRETE REINFORCEMENT					
W04	REHABILITATED HISTORIC STONE STEPS AT LARGE LAMBERT BEACH STAIR					
W05	REHABILITATED HISTORIC STONE "BENCH" AT LAMBERT BEACH STONE STAIR					

STA	STAIR SCHEDULE (S)				
KEY	DESCRIPTION				
S01	REHABILITATED HISTORIC CONCRETE STAIRS AND STONE COBBLE STAIR WALLS				
S02	NEW STONE COBBLE STAIRS ON CONCRETE FOUNDATION				
S03	PORTLAND GRAY CONCRETE STAIRS				
S04	REHABILITATED HISTORIC MASONRY STAIRS				





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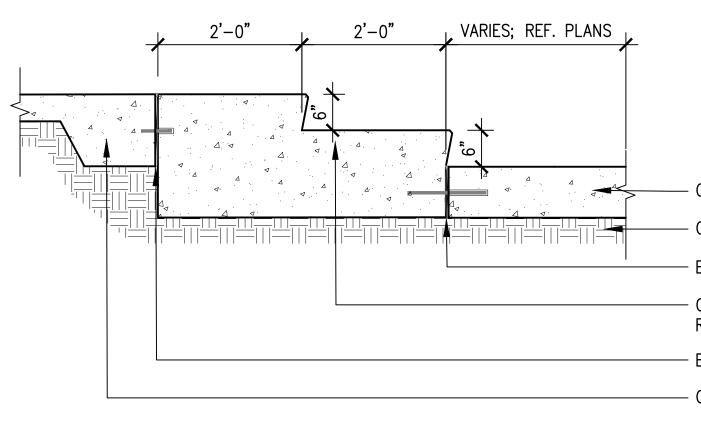
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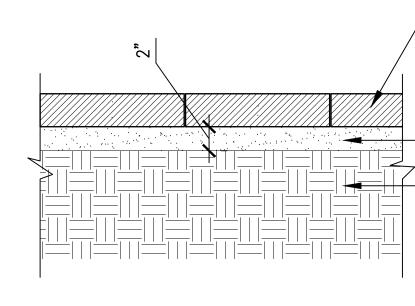
 Λ ADDENDUM 01 03/10/2023

Date	
11 JANUARY 2023	
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95% CONSTRUCTION DOCUME	ENTS
Job Number	
CNOS701	
Scale	North
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LAYOUT AND MA	FERIALS PLAN
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- CONCRETE PAVING; REF. CIVIL COMPACTED SUBGRADE; REF. CIVIL - EXPANSION JOINT AND DOWEL ROD CONCRETE STAIRS; REF. CIVIL FOR REINFORCEMENT - EXPANSION JOINT AND DOWEL ROD - CONCRETE LANDING; REF. CIVIL


$(05) \frac{\text{SECTION} - (S03) \text{ CONCRETE STAIRS}}{3/4" = 1'-0"}$



REPLACED PAVER (TYP.); MATCH PAVER SPACING TO EXISTING PAVERS

- SAND SETTING BED, REF. SPECS

 $\underbrace{04}_{1 1/2" = 1'-0"} \underbrace{\text{SECTION} - \text{DISTURBED PAVER REPLACEMENT DETAIL}_{1 1/2" = 1'-0"}$

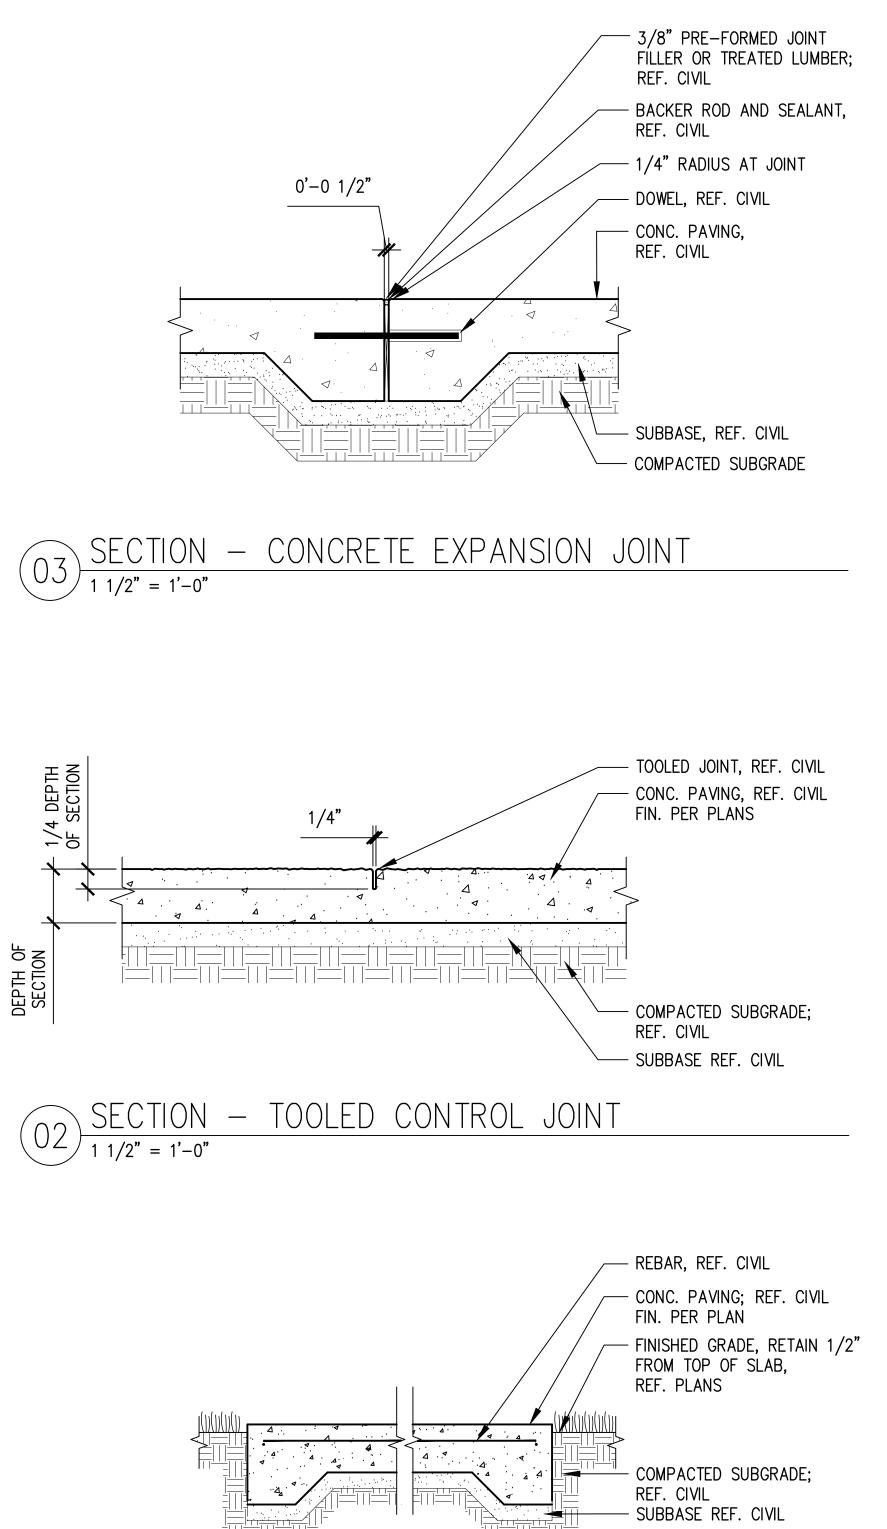

 $(01) \frac{\text{SECTION} - \text{TYPICAL CONCRETE PAVING}}{1" = 1'-0"}$

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Scale


North

Drawing Title

HARDSCAPE DETAILS

L4.01

Drawing Number

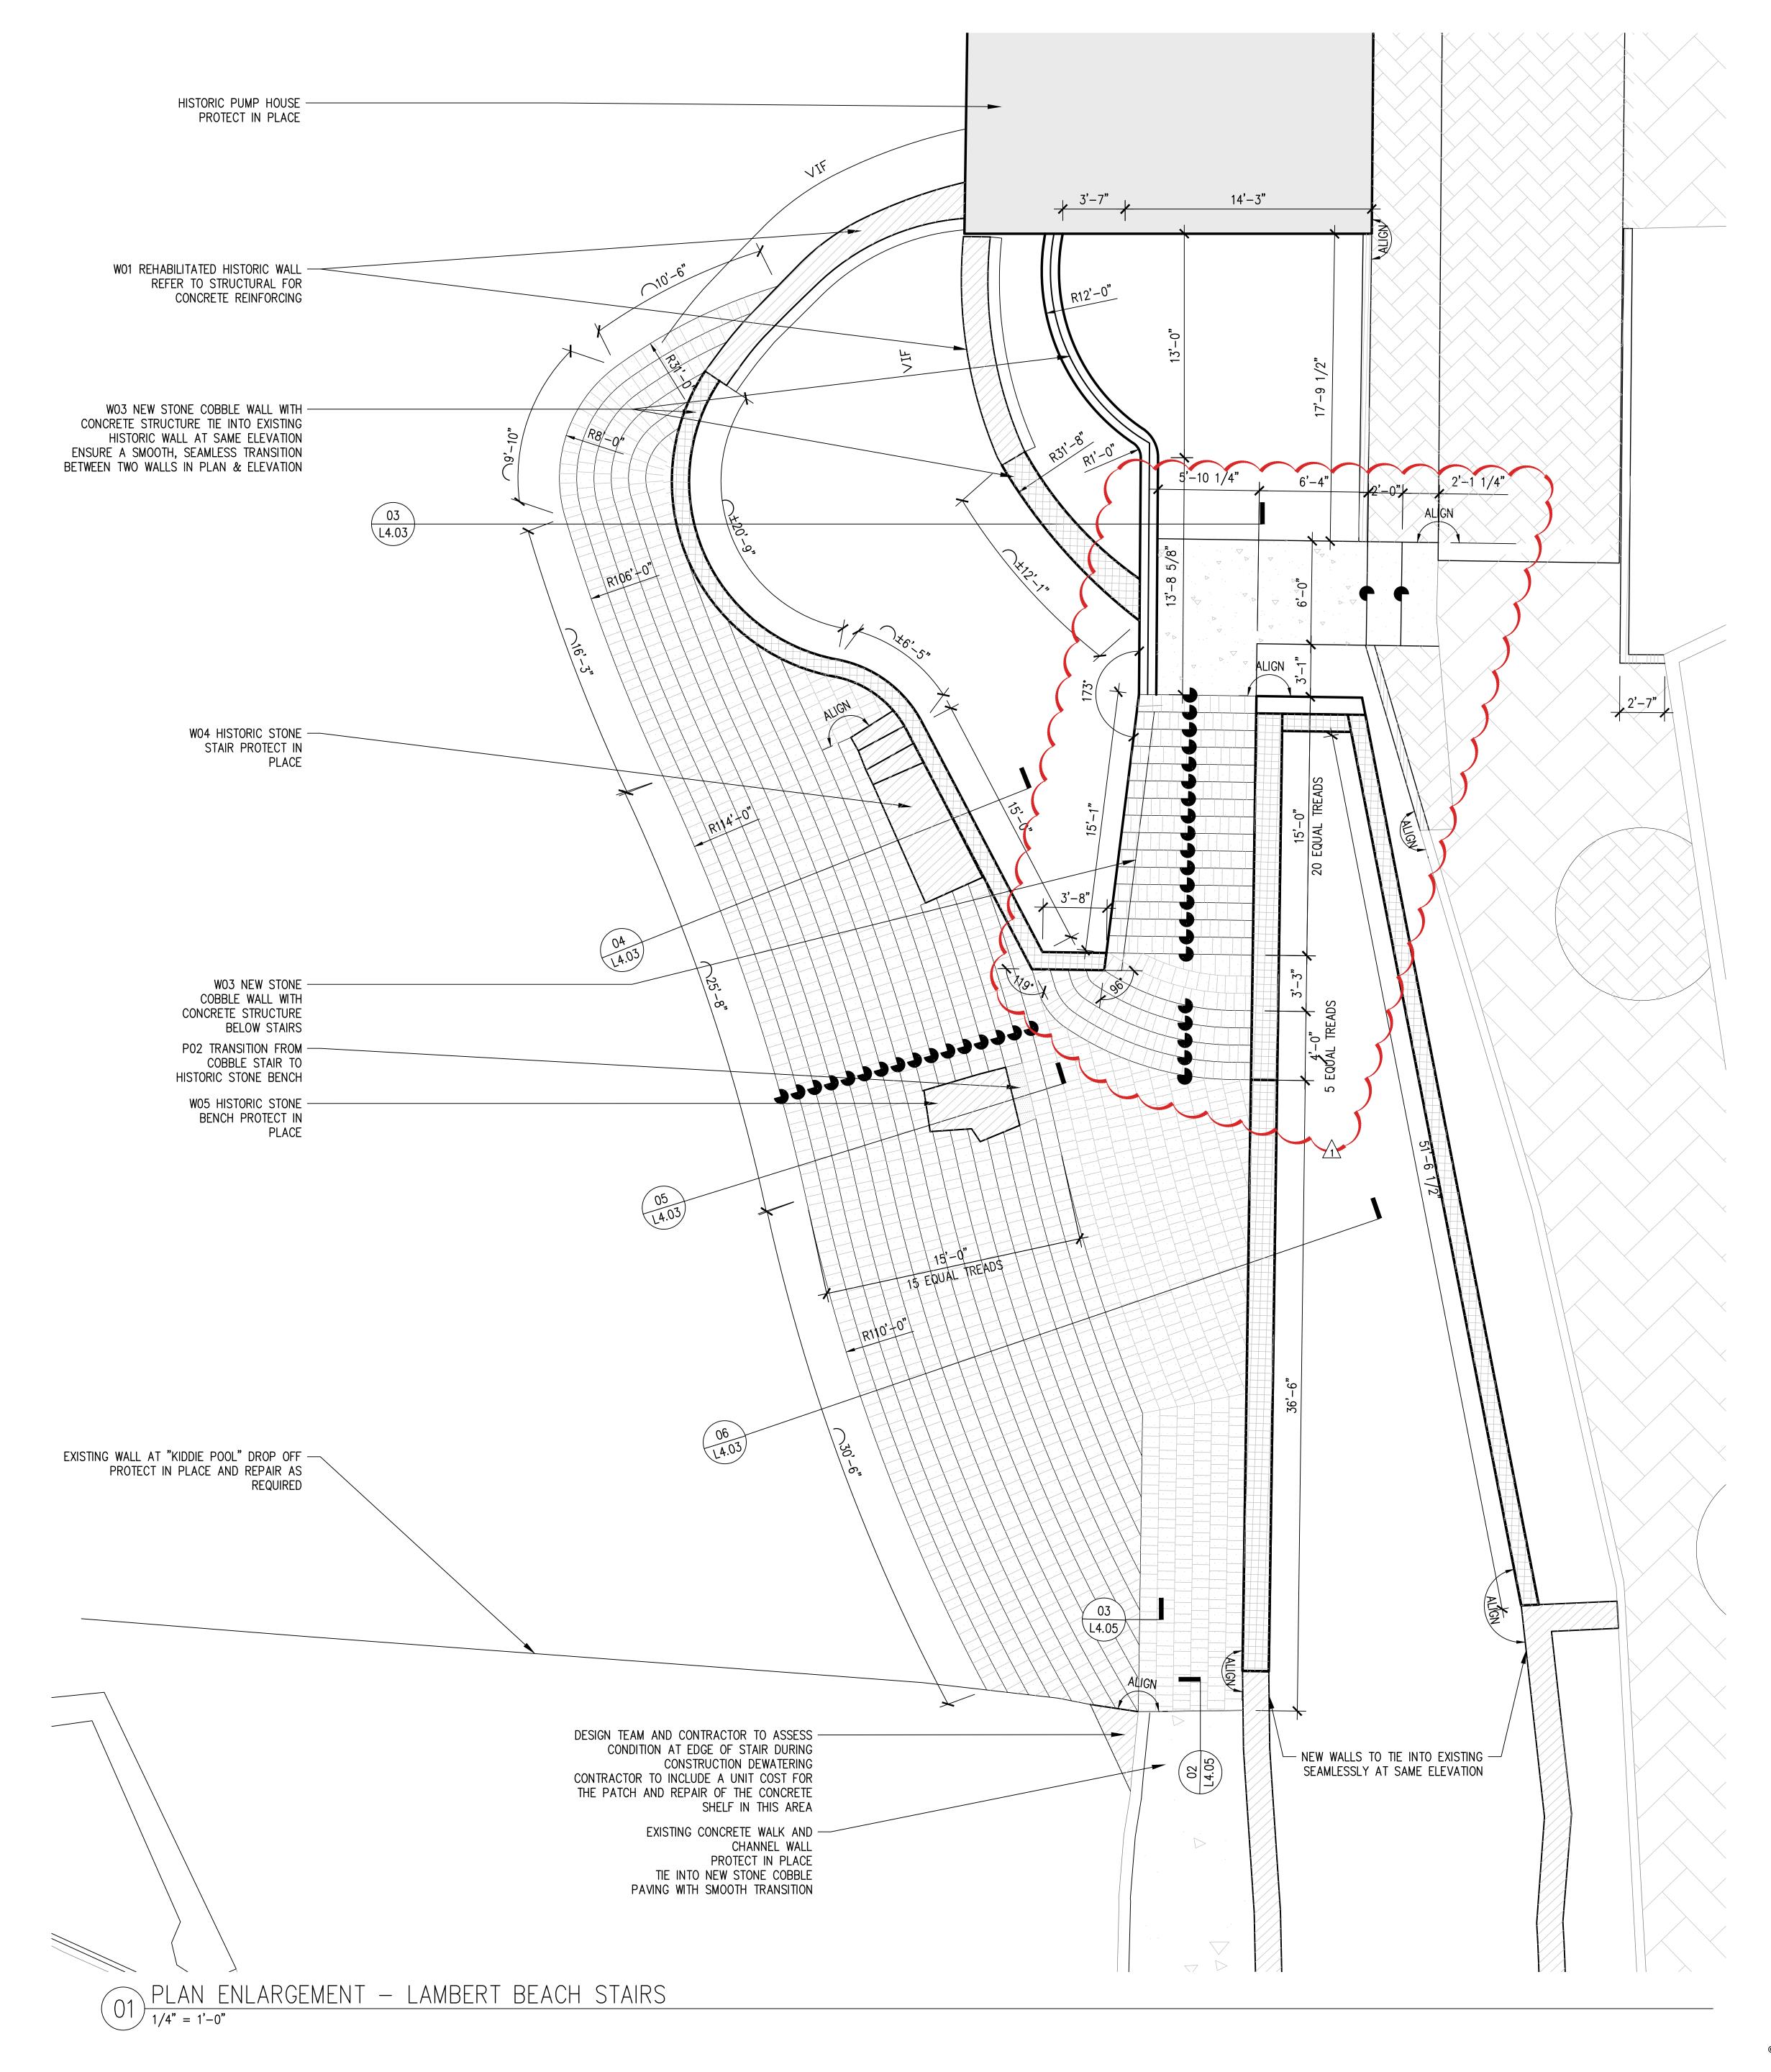

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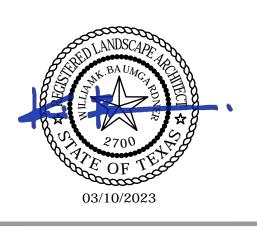
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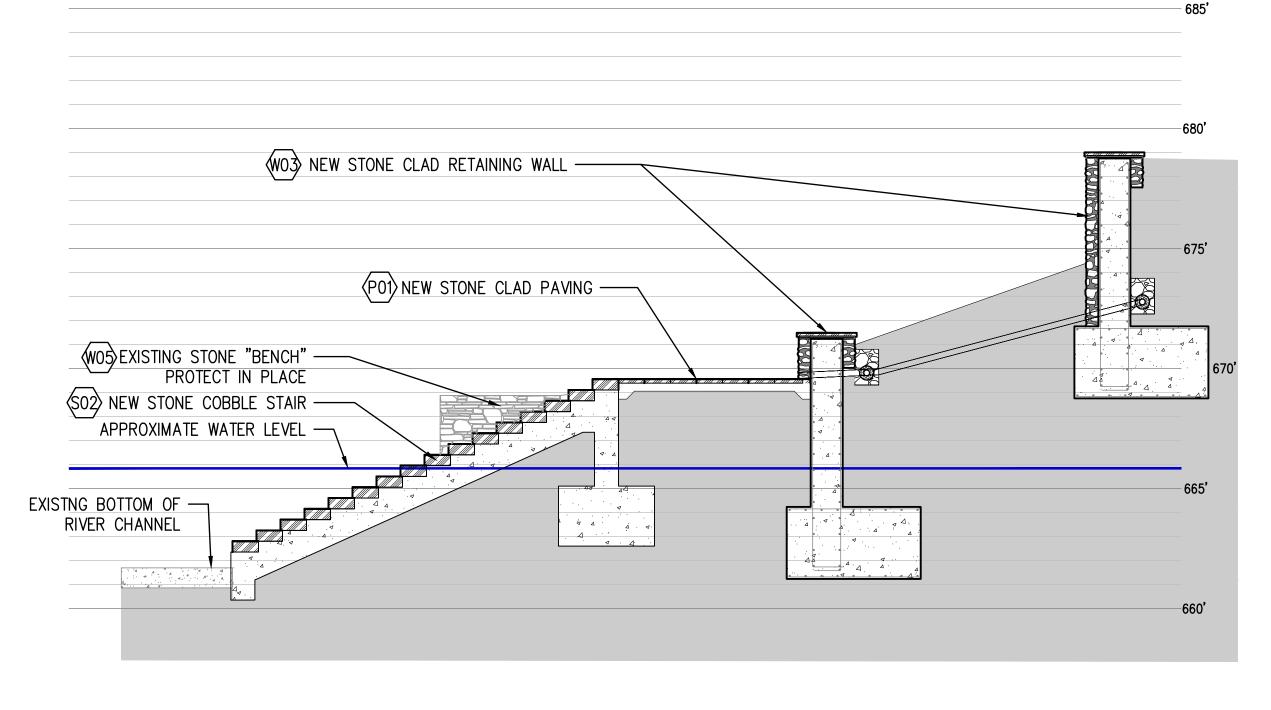


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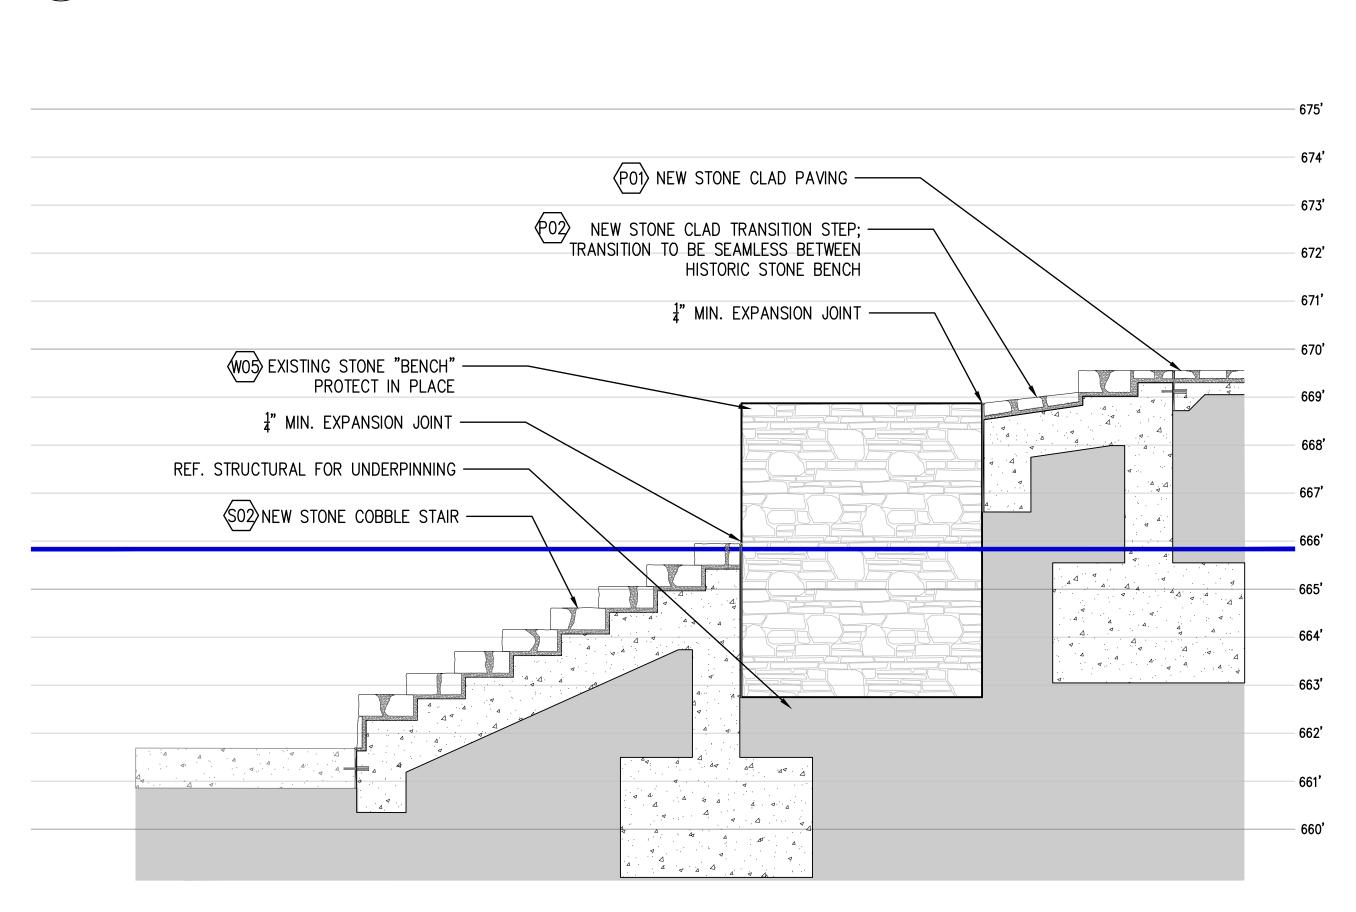
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Date 11 JANUARY 2023 Phase 95% CONSTRUCTION DOCUMENTS Job Number CNOS701 Scale North COSTO Scale North COSTO Drawing Title HARDSCAPE DETAILS


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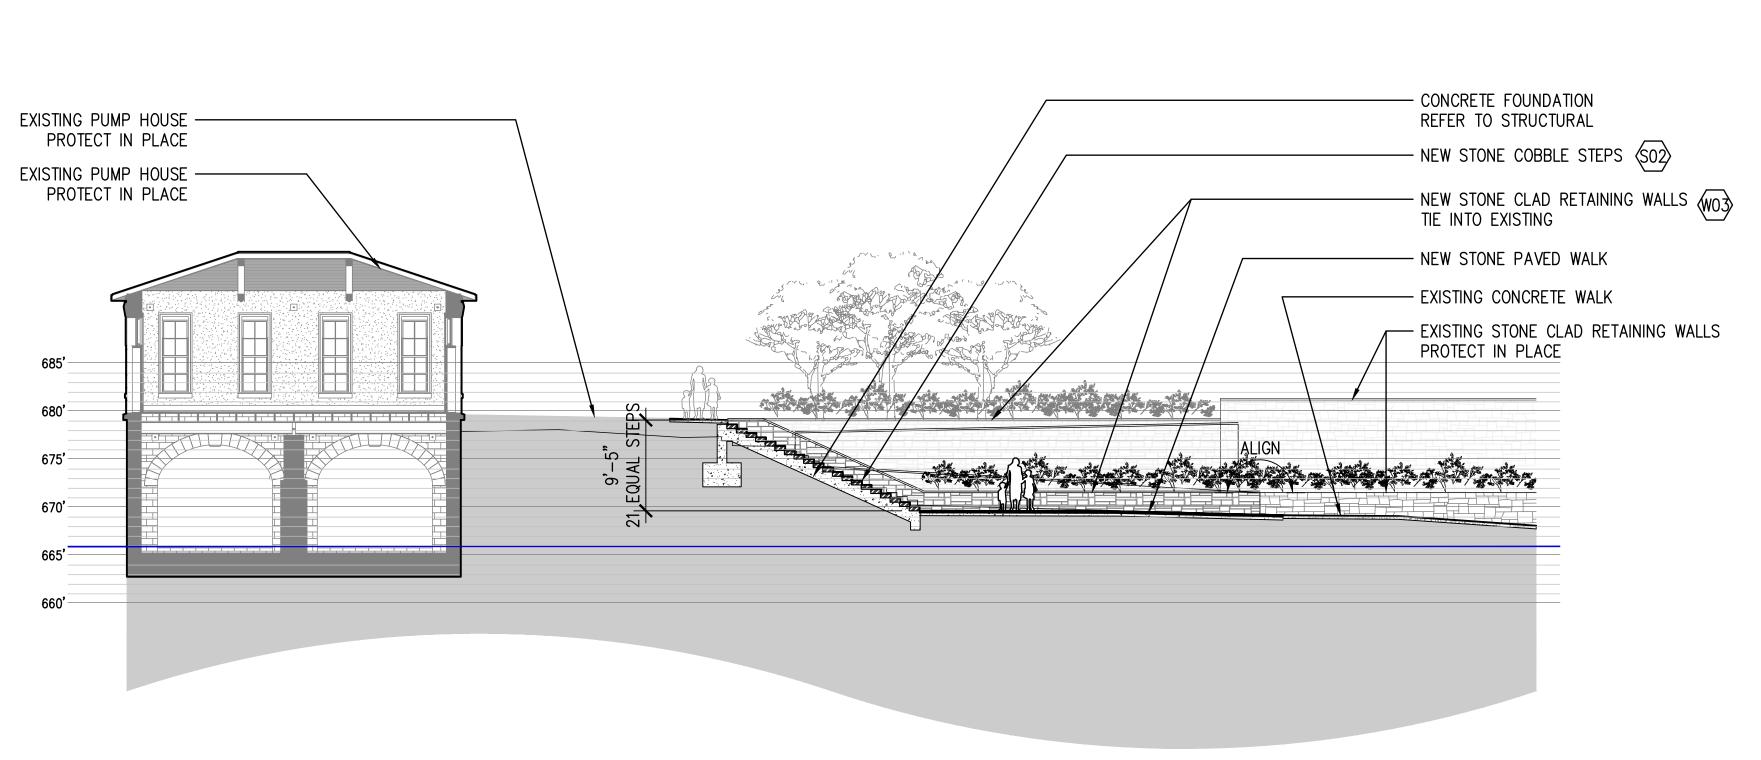
7) <u>SECTION – LAMBERT BEACH STAIR AT STONE LANDING</u> 1/4"=1'-0" (07)




SECTION ENLARGEMENT - LAMBERT BEACH STAIR AT HISTORIC STONE BENCH (06) 1/2" = 1'-0"






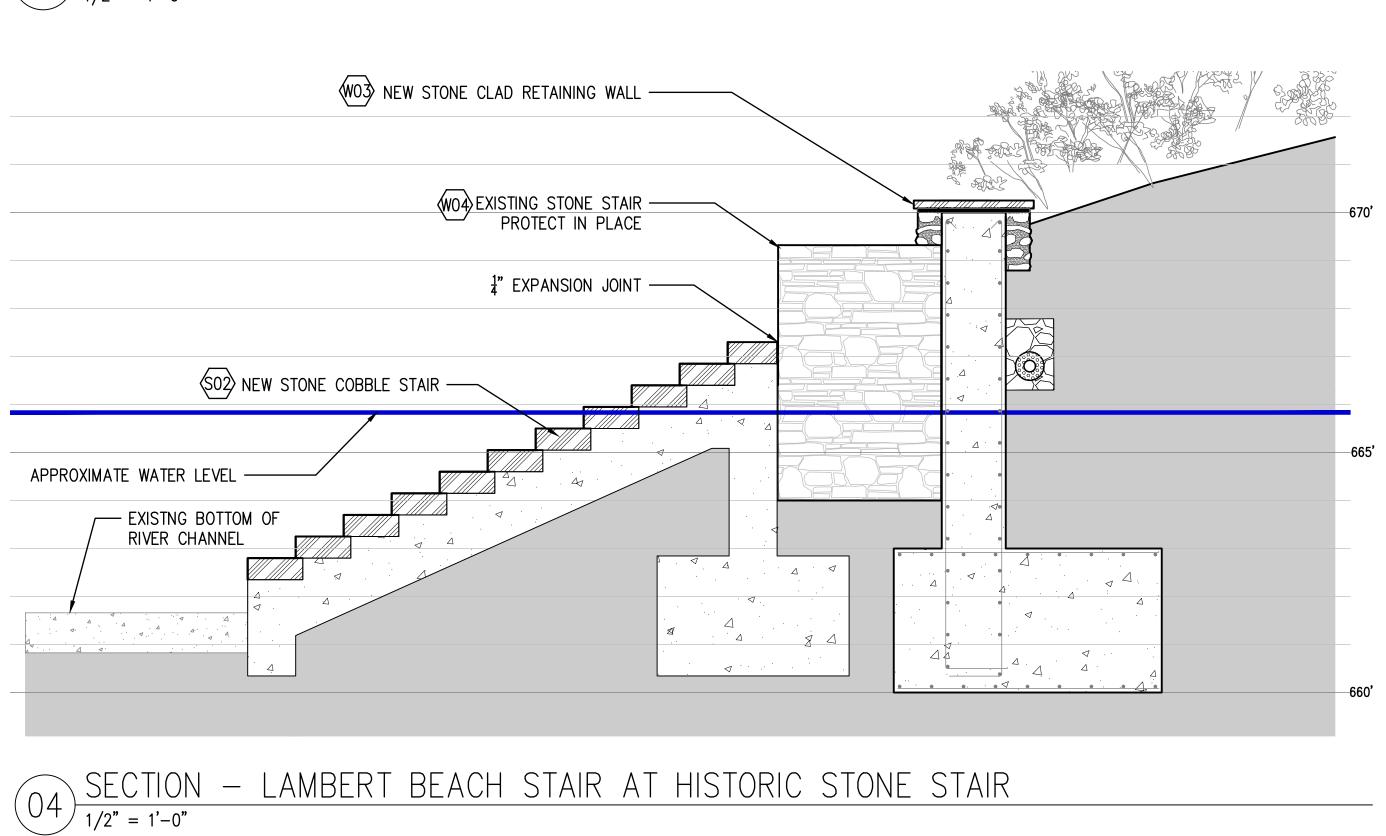



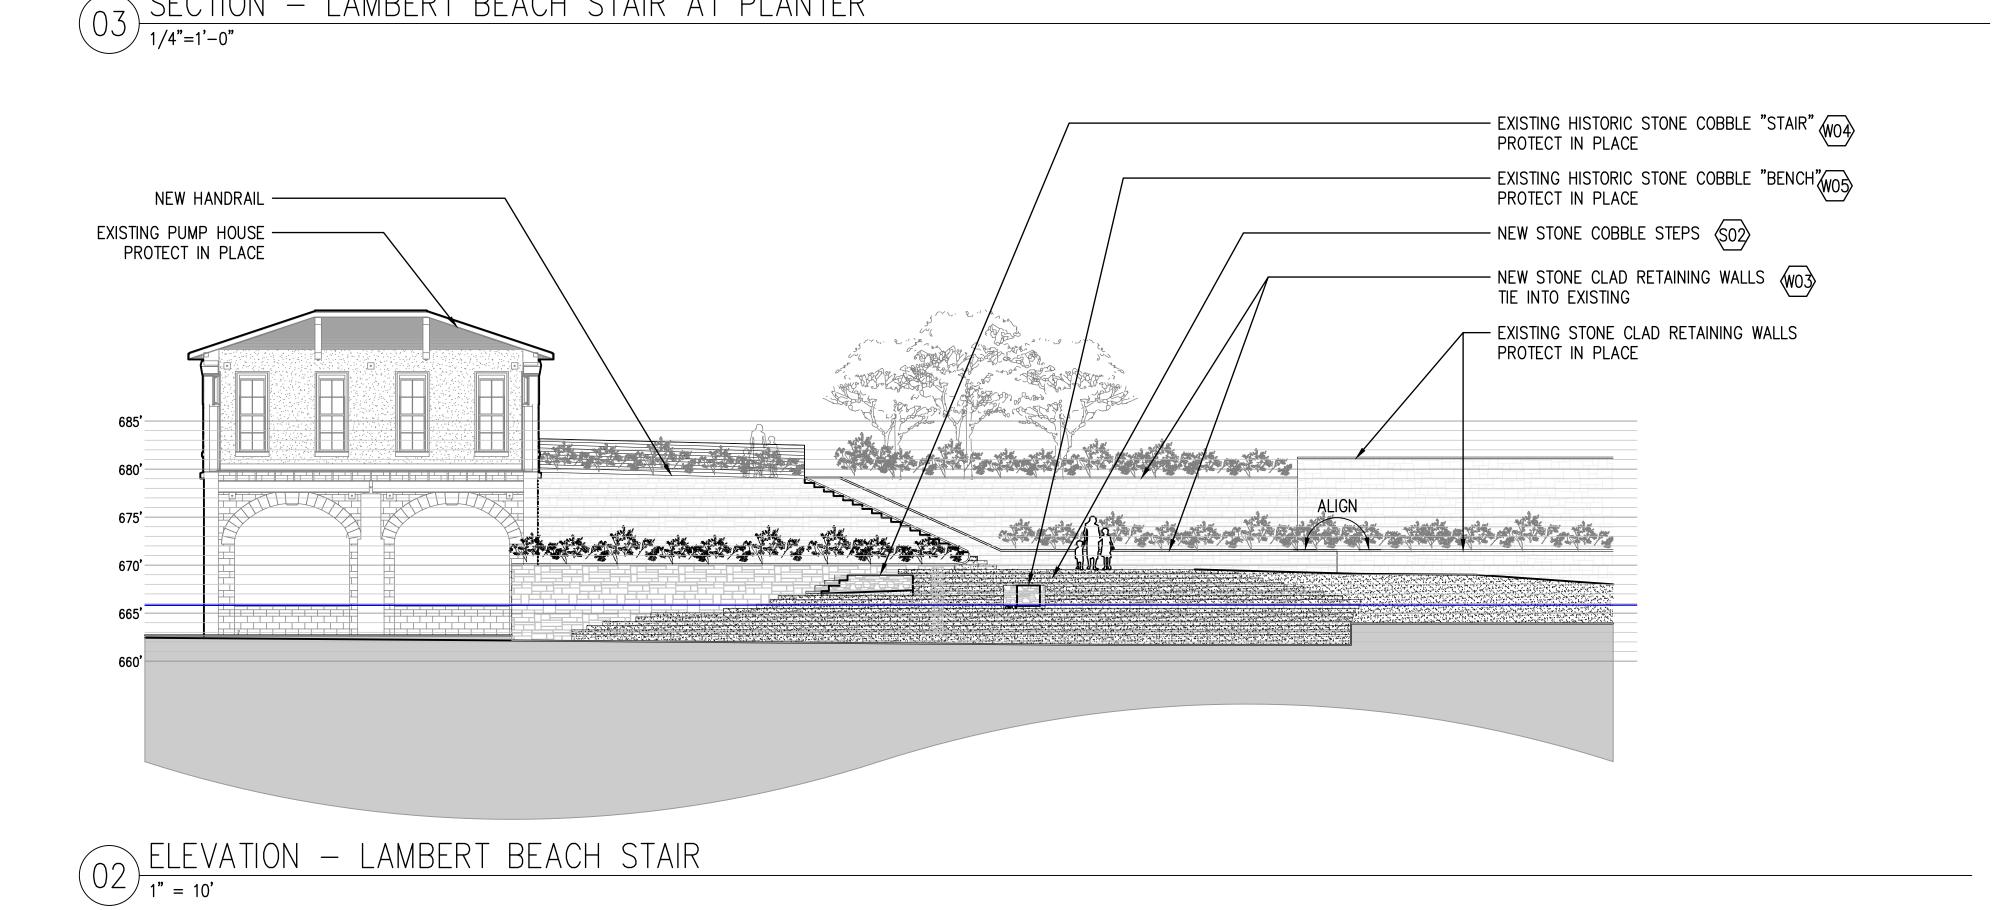

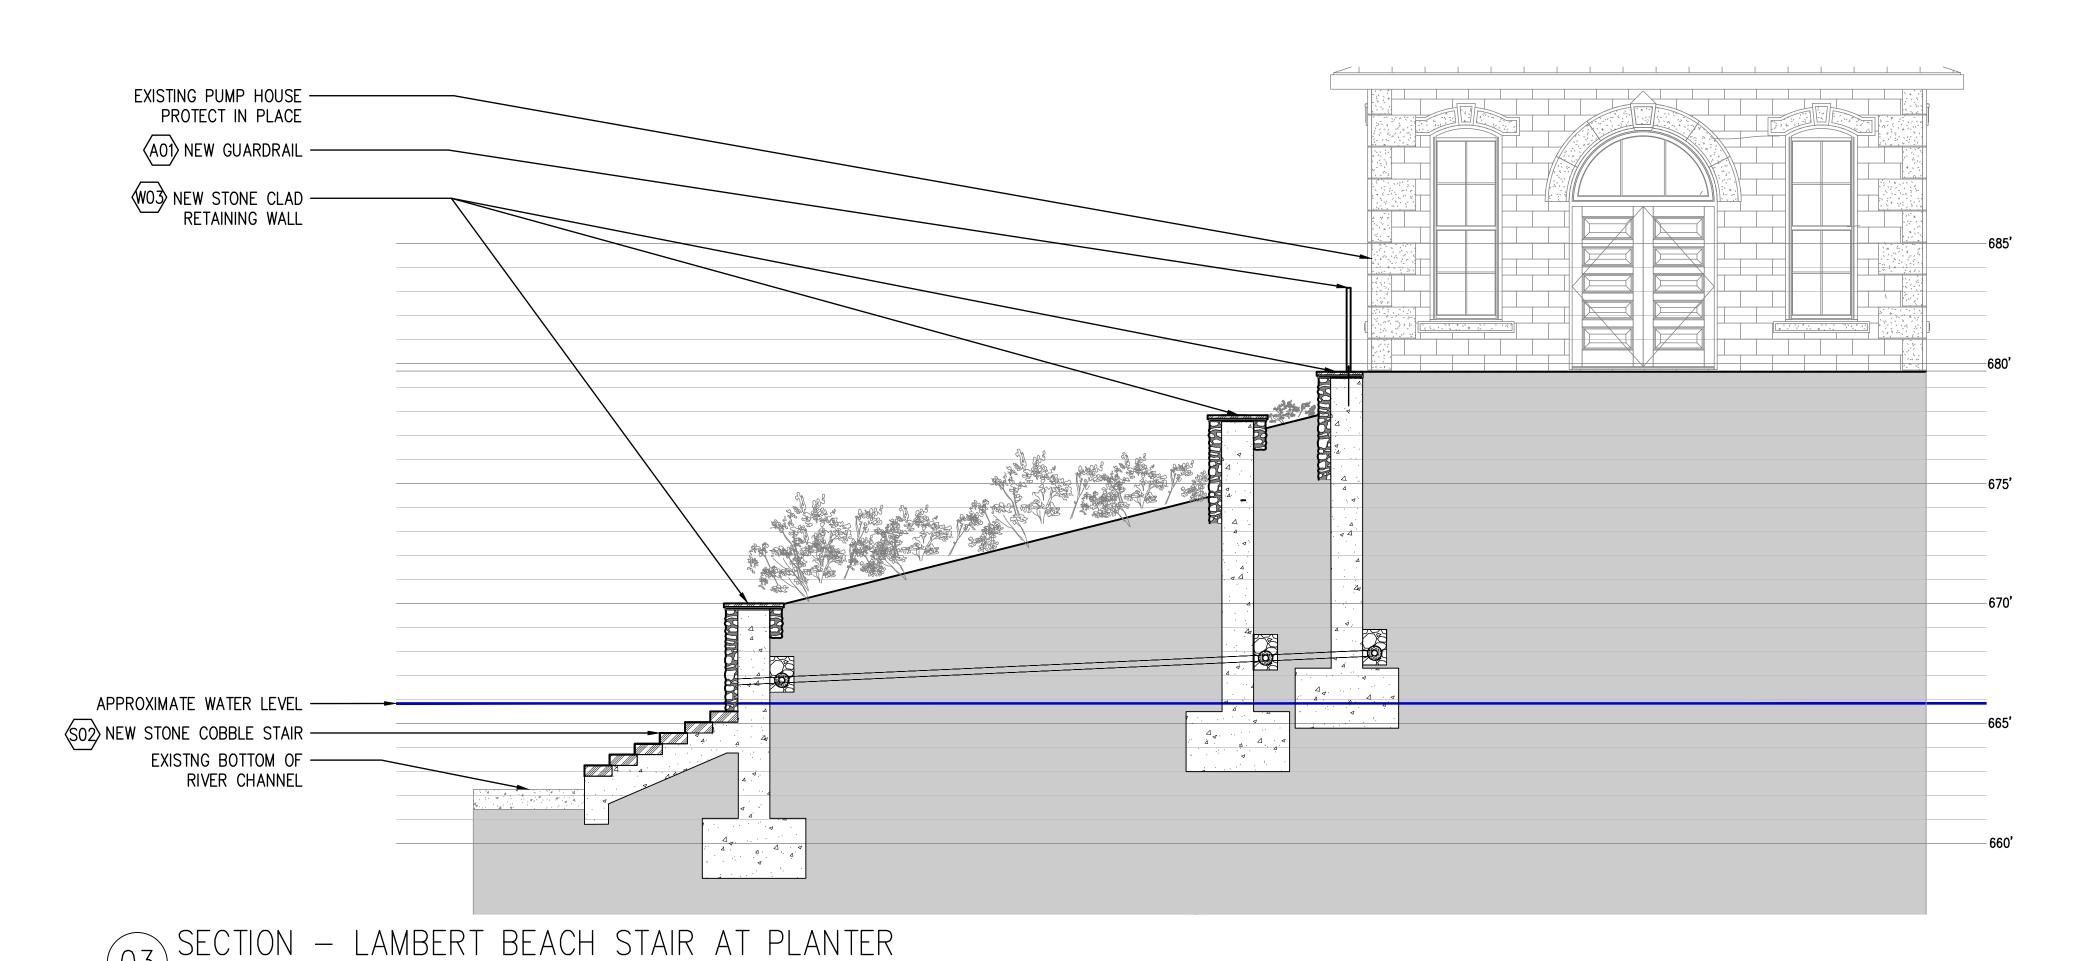

BRACKENRIDGE PARK

SAN ANTONIO, TX

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LANDSCAPE ARCHITECT



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SEVENTH GENERATION DESIGN HISTORIC ARCHITECT 933 NORTH FLORES STREET, SUITE B SAN ANTONIO, TX 78212

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LUNDY & FRANKE ENGINEERING STRUCTURAL ENGINEER 549 HEIMER SAN ANTONIO, TX 78232

INTELLIGENT ENGINEERING SERVICES C**IVIL ENGINEER** 1045 CENTRAL PARKWAY NORTH, SUITE 200, SAN ANTONIO, TX 78232

TRUE NORTH CONSULTING GROUP IT AND COMMUNICATIONS 13284 POND SPRINGS ROAD, STE. 304 AUSTIN TX, 78729

CNG ENGINEERING MEP

1917 N. NEW BRAUNFELS AVE., SUITE 201, SAN ANTONIO TX, 78208

WGI ENGINEERING HYDROLOGY 5710 W HAUSMAN RD. SAN ANTONIO, TX 78249

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Date 11 JANUARY 2023 Phase 95% CONSTRUCTION DOCUMENTS Job Number CNOS701

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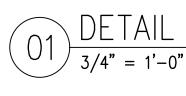
HARDSCAPE DETAILS

Drawing Number


L4.03




PHOTO OF DETERIORATED WALL



(W02A) HISTORIC WALL RECONSTRUCTION A

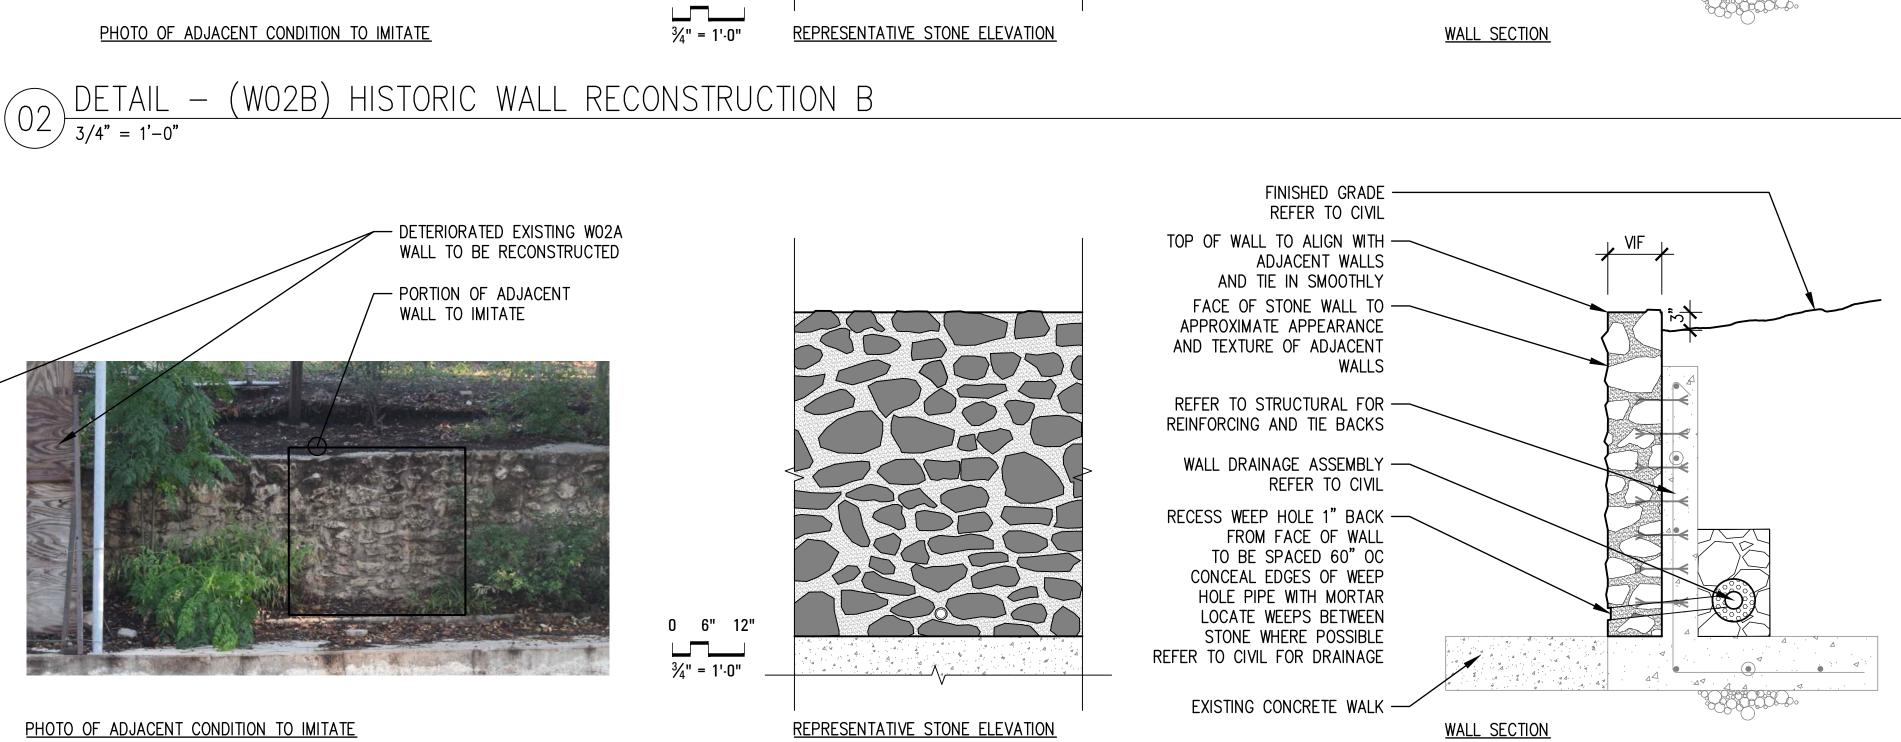



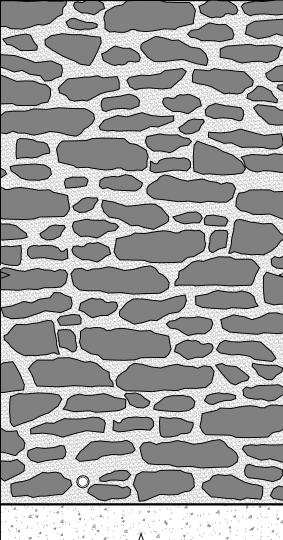

 $O3 \xrightarrow{\text{DETAILS} - (WO3) \text{ NEW STONE WALL WITH COBBLE AND CONC. REINFORCEMENT}}{3/4" = 1'-0"}$

0 6" 12"

³⁄₄" = 1'-0"

0 6" 12"

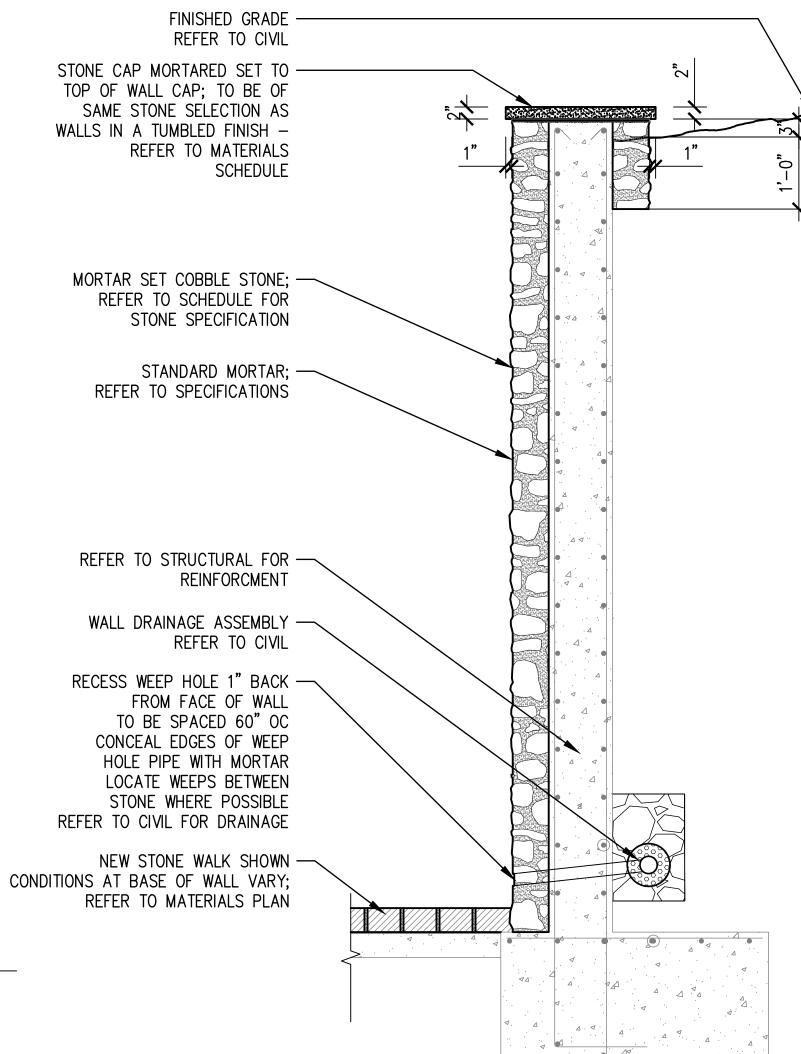


PHOTO OF ADJACENT CONDITION TO IMITATE

TO IMITATE IN CHARACTER


- PORTION OF ADJACENT WALL

REPRESENTATIVE STONE ELEVATION



NOTES:

- REFER TO GENERAL NOTES ON SHEET L0.02. REFER TO HISTORIC STONE SPECIFICATIONS FOR TREATMENT OF ADJACENT HISTORIC WALLS.
- CONTRACTOR TO PROVIDE OF MOCK UP OF WALLS FOR DESIGN TEAM, CLIENT, AND **REGULATORY APPROVAL**
- NEW STONE SHALL BE SIMILAR IN SHAPE, SIZE, AND FINISH OF ADJACENT HISTORIC
- STONE. REFER TO SPECIFICATIONS FOR STANDARD MORTAR APPLICATION.

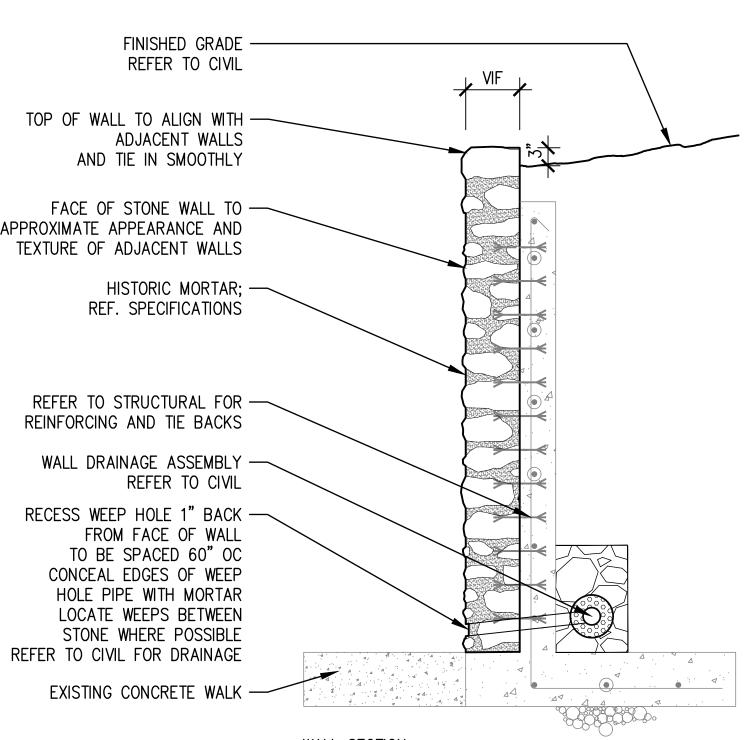

WALL SECTION

NOTES:

- REFER TO GENERAL NOTES ON SHEET L0.02. 2. REFER TO HISTORIC STONE SPECIFICATIONS FOR TREATMENT OF HISTORIC WALLS INCLUDING REPAIR/REPOINTING, REMOVAL
- AND DISMANTLING, MORTAR, AND CLEANING. CONTRACTOR TO PROVIDE OF MOCK UP OF WALLS FOR DESIGN TEAM, CLIENT, AND
- REGULATORY APPROVAL. 4. ALL DETERIORATED STONE FROM EXISTING STONE IS TO BE SALVAGED PER MASONRY SPECIFICATIONS FOR RE-USE IN WALL REHABILITATION.
- ANY ADDITIONAL STONE ASIDE FROM SALVAGED STONE REQUIRED IN REHABILITATED WALLS TO BE SAME IN KIND, SIZE, FINISH, AND APPEARANCE AS EXISTING HISTORIC MASONRY.
- CONTRACTOR TO ENSURE ALL TIE BACKS AND REINFORCEMENTS ARE INSTALLED IN MORTAR JOINTS RATHER THAN MASONRY TO MINIMIZE DAMAGE TO HISTORIC MATERIAL.

NOTES:

- REFER TO GENERAL NOTES ON SHEET LO.02. REFER TO HISTORIC STONE SPECIFICATIONS 2. FOR TREATMENT OF HISTORIC WALLS INCLUDING REPAIR/REPOINTING, REMOVAL
- AND DISMANTLING, MORTAR, AND CLEANING. CONTRACTOR TO PROVIDE OF MOCK UP OF WALLS FOR DESIGN TEAM, CLIENT, AND
- REGULATORY APPROVAL. ALL DETERIORATED STONE FROM EXISTING STONE IS TO BE SALVAGED PER MASONRY SPECIFICATIONS FOR RE-USE IN WALL REHABILITATION.
- ANY ADDITIONAL STONE ASIDE FROM SALVAGED STONE REQUIRED IN REHABILITATED WALLS TO BE SAME IN KIND, SIZE, FINISH, AND APPEARANCE AS EXISTING HISTORIC MASONRY.
- CONTRACTOR TO ENSURE ALL TIE BACKS AND REINFORCEMENTS ARE INSTALLED IN MORTAR JOINTS RATHER THAN MASONRY TO MINIMIZE DAMAGE TO HISTORIC MATERIAL

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WGI ENGINEERING HYDROLOGY 5710 W HAUSMAN RD. SAN ANTONIO, TX 78249

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Revisions

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Date 11 JANUARY 2023 Phase 95% CONSTRUCTION DOCUMENTS Job Number CNOS701


Scale

Drawing Title

HARDSCAPE DETAILS

Drawing Number


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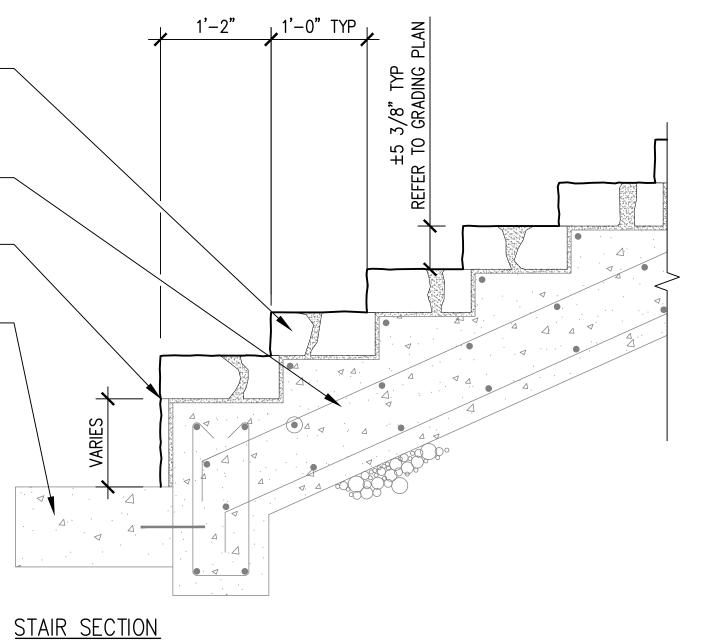


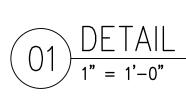
MORTAR SET LIMESTONE COBBLE STEPS -ALL RISERS TO BE EQUAL HEIGHT REFER TO MATERIALS SCHEDULE FOR COLOR AND FINISH

REFER TO STRUCTURAL FOR — FOUNDATION AND REINFORCING

EXTEND BOTTOM STEP TWO — INCHES TO COVER THIN SET CLADDING AT BASE OF STAIR EXISTING RIVER CHANNEL

BOTTOM

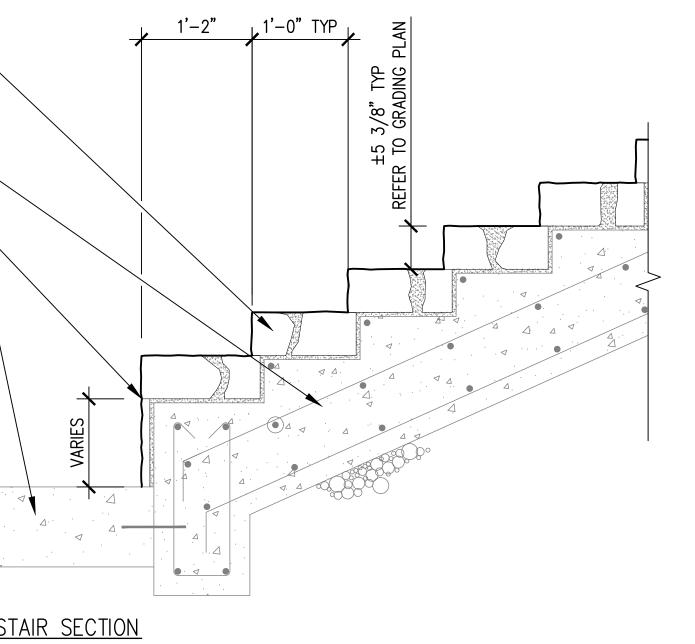


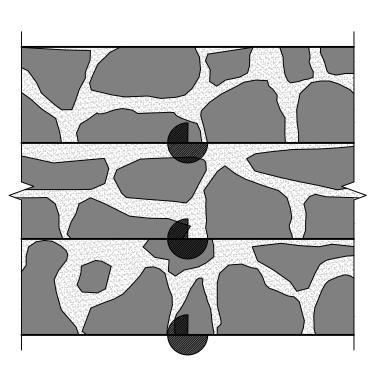

REPRESENTATIVE STONE PLAN


PHOTO OF CONDITION TO IMITATE

 $\underbrace{O1}_{1" = 1'-0"} \underbrace{\text{DETAIL} - (SO2) \text{ LARGE LAMBERT BEACH STAIR DETAILS}}_{1" = 1'-0"}$

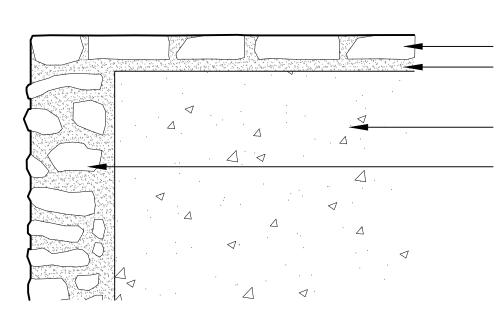

- EXISTING CONCRETE LANDING — NEW STONE WALL CLADDING; WO3 REF. 03/L4.04

O3 SECTION - STONE CLADDING AT EXISTING CONCRETE LANDING

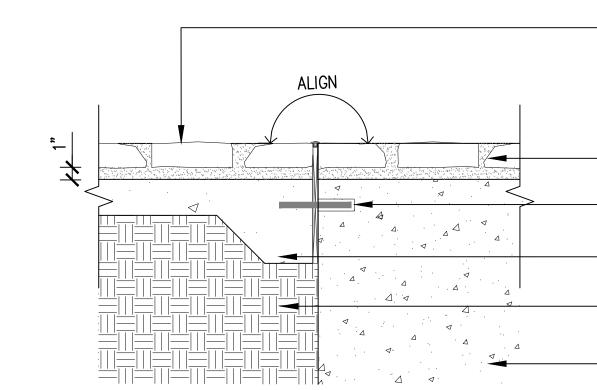

- NEW LIMESTONE PAVING (P01) ON MORTAR; REF. MATERIALS SCHEDULE

- NEW STONE PAVING CLADDING; REF. 03/L4.05 $\frac{1}{4}$ EXPANSION JOINT WITH DOWEL; DRILL AND EPOXY-SET - CONCRETE SUB-BASE; REF. STRUCTURAL - COMPACTED SUB-GRADE; REF. STRUCTURAL - EXISTING CONCRETE LANDING

$(02) \frac{\text{SECTION} - \text{NEW STONE LANDING AT EXISTING CONCRETE LANDING}{1 1/2" = 1'-0"}$

NOTES:

- REFER TO GENERAL NOTES ON SHEET LO.02.
- REFER TO PLAN FOR EXISTING HISTORIC STEPS TO REMAIN.
- REFER TO SPECIFICATIONS FOR TREATMENT OF ADJACENT HISTORIC STRUCTURES.
- HISTORIC STONE MASON TO PROVIDE MOCK UPS OF EACH STAIR TYPE PRIOR TO INSTALLATION FOR LANDSCAPE ARCHITECT, ARCHITECT, THC, AND OHP APPROVAL.
- NEW STONE SHALL BE SIMILAR IN SHAPE, SIZE, AND FINISH OF ADJACENT HISTORIC STONE.
- REFER TO SPECIFICATIONS FOR STANDARD MORTAR APPLICATION.

BRACKENRIDGE PARK

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Revisions

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Date 11 JANUARY 2023 Phase 95% CONSTRUCTION DOCUMENTS Job Number CNOS701

Scale

Drawing Title

HARDSCAPE DETAILS

L4.05

Drawing Number

BRAKENRIDGE PLANTING SCHEDULE - PHASE 1

SHADE TREES

YM.	Botanical Name	Common Name		Quantity	Units	Size	Cal.	Height	Spread	Remarks
גע∧ב	Quercus virginiana	Live Oak	-	4	EA	200 gal.	6"	18'-20'	20'	Central Leader, Symmetrical & Full
RNA	MENTAL & SMALL TREES									
SYM.	Botanical Name	Common Name		Quantity	Units	Size	Cal.	Height	Spread	Remarks
ID	Ilex decidua 'Walter'	Possumhaw	-	3	EA	45 gal.	2 1/2"	8-10'	4-5'	Full plants rooted to container
IV	llex vomitoria	Yaupon Holly (Upright)	-	5	EA	45 gal.	2 1/2"	8-10'	4-5'	Full plants rooted to container
SP	Sophora secundiflora	Texas Mountain Laurel	-	3	EA	45 gal.	2 1/2"	8-10'	4-5'	Full plants rooted to container
						45 mal	0.4 (0)	a (a)	4 61	
	Viburnum rufidulum JENTAL MIX - A	Rusty Blackhaw Viburnum	-	11	EA	45 gal.	2 1/2"	8-10'	4-5'	Full plants rooted to container
RNAN		Rusty Blackhaw Viburnum Common Name	- % of mix	Quantity	EA Units	45 gai.	2 1/2" Height	Spread	Spacing	
RNAN	/IENTAL MIX - A									
RNA	/IENTAL MIX - A Botanical Name	Common Name	% of mix	Quantity	Units	Size	Height	Spread	Spacing	Remarks
VR DRNAN SYM.	MENTAL MIX - A Botanical Name Aristida purpurea	Common Name Purple Threeawn	% of mix 15%	Quantity 330	Units EA	Size 1 gal.	Height 18"	Spread 18"	Spacing 18"	Remarks Full plants rooted to container
RNA	IENTAL MIX - A Botanical Name Aristida purpurea Bouteloua gracilis	Common Name Purple Threeawn Blue Grama	% of mix 15% 10%	Quantity 330 222	Units EA EA	Size 1 gal. 1 gal.	Height 18" 18"	Spread 18" 18"	Spacing 18" 18"	Remarks Full plants rooted to container Full plants rooted to container
ORNAN SYM.	MENTAL MIX - A Botanical Name Aristida purpurea Bouteloua gracilis Elymus canadensis	Common Name Purple Threeawn Blue Grama Canada Wild Rye	% of mix 15% 10% 15%	Quantity 330 222 330	Units EA EA EA	Size 1 gal. 1 gal. 1 gal.	Height 18" 18" 18"	Spread 18" 18" 18"	Spacing 18" 18" 18"	Remarks Full plants rooted to container Full plants rooted to container Full plants rooted to container
ORNAN SYM.	MENTAL MIX - A Botanical Name Aristida purpurea Bouteloua gracilis Elymus canadensis Malvaiscus arboreus	Common Name Purple Threeawn Blue Grama Canada Wild Rye Turk's Cap	% of mix 15% 10% 15% 15% 15%	Quantity 330 222 330 187	Units EA EA EA EA	Size 1 gal. 1 gal. 1 gal. 5 gal.	Height 18" 18" 18" 24"	Spread 18" 18" 18" 24"	Spacing 18" 18" 18" 24"	Remarks Full plants rooted to container Full plants rooted to container Full plants rooted to container Full plants rooted to container
RNAN SYM.	MENTAL MIX - A Botanical Name Aristida purpurea Bouteloua gracilis Elymus canadensis Malvaiscus arboreus Muhlenbergia lindheimeri	Common NamePurple ThreeawnBlue GramaCanada Wild RyeTurk's CapLindheimer's Muhly	% of mix 15% 10% 15% 15% 15% 15% 15%	Quantity 330 222 330 187 118	Units EA EA EA EA EA	Size 1 gal. 1 gal. 1 gal. 5 gal. 1 gal.	Height 18" 18" 18" 24" 18"	Spread 18" 18" 18" 24" 15"	Spacing 18" 18" 18" 24" 30"	Remarks Full plants rooted to container Full plants rooted to container Full plants rooted to container Full plants rooted to container Full plants rooted to container

YM.	Botanical Name	Common Name		Quantity	Units	Size	Cal.	Height	Spread	Remarks
QVA	Quercus virginiana	Live Oak	-	4	EA	200 gal.	6"	18'-20'	20'	Central Leader, Symmetrical & Full
RNAN	IENTAL & SMALL TREES									
SYM.	Botanical Name	Common Name		Quantity	Units	Size	Cal.	Height	Spread	Remarks
ID	llex decidua 'Walter'	Possumhaw	-	3	EA	45 gal.	2 1/2"	8-10'	4-5'	Full plants rooted to container
IV	llex vomitoria	Yaupon Holly (Upright)	-	5	EA	45 gal.	2 1/2"	8-10'	4-5'	Full plants rooted to container
SP	Sophora secundiflora	Texas Mountain Laurel	-	3	EA	45 gal.	2 1/2"	8-10'	4-5'	Full plants rooted to container
		T T	i							
I	Viburnum rufidulum IENTAL MIX - A	Rusty Blackhaw Viburnum	-	11	EA	45 gal.	2 1/2"	8-10'	4-5'	Full plants rooted to container
RNAN		Rusty Blackhaw Viburnum Common Name	- % of mix	11 Quantity		45 gal. Size	2 1/2"	8-10' Spread	4-5'	
RNAN	IENTAL MIX - A		- % of mix 15%							
RNAN	IENTAL MIX - A Botanical Name	Common Name		Quantity	Units	Size	Height	Spread	Spacing	Remarks
RNAN	IENTAL MIX - A Botanical Name Aristida purpurea	Common Name Purple Threeawn	15%	Quantity 330	Units EA	Size 1 gal.	Height 18"	Spread 18"	Spacing 18"	Remarks Full plants rooted to container
VR PRNAM SYM.	IENTAL MIX - A Botanical Name Aristida purpurea Bouteloua gracilis	Common Name Purple Threeawn Blue Grama	15% 10%	Quantity 330 222	Units EA EA	Size 1 gal. 1 gal.	Height 18" 18"	Spread 18″ 18″	Spacing 18" 18"	Remarks Full plants rooted to container Full plants rooted to container
PRNAM SYM.	IENTAL MIX - A Botanical Name Aristida purpurea Bouteloua gracilis Elymus canadensis	Common Name Purple Threeawn Blue Grama Canada Wild Rye	15% 10% 15%	Quantity 330 222 330	Units EA EA EA	Size 1 gal. 1 gal. 1 gal.	Height 18" 18" 18"	Spread 18" 18" 18"	Spacing 18" 18" 18"	Remarks Full plants rooted to container Full plants rooted to container Full plants rooted to container
RNAM SYM.	AENTAL MIX - A Botanical Name Aristida purpurea Bouteloua gracilis Elymus canadensis Malvaiscus arboreus	Common Name Purple Threeawn Blue Grama Canada Wild Rye Turk's Cap	15% 10% 15% 15%	Quantity 330 222 330 187	Units EA EA EA EA	Size 1 gal. 1 gal. 1 gal. 5 gal.	Height 18" 18" 18" 24"	Spread 18" 18" 18" 24"	Spacing 18" 18" 18" 24"	Remarks Full plants rooted to container Full plants rooted to container Full plants rooted to container Full plants rooted to container
RNAM SYM.	Alental MIX - A Botanical Name Aristida purpurea Bouteloua gracilis Elymus canadensis Malvaiscus arboreus Muhlenbergia lindheimeri	Common Name Purple Threeawn Blue Grama Canada Wild Rye Turk's Cap Lindheimer's Muhly	15% 10% 15% 15% 15%	Quantity 330 222 330 187 118	Units EA EA EA EA EA	Size 1 gal. 1 gal. 1 gal. 5 gal. 1 gal.	Height 18" 18" 18" 24" 18"	Spread 18" 18" 18" 24" 15"	Spacing 18" 18" 18" 24" 30"	Remarks Full plants rooted to container

SYM.	Botanical Name	Common Name		Quantity	Units	Size	Cal.	Height	Spread	Remarks
QVA	Quercus virginiana	Live Oak	-	4	EA	200 gal.	6"	18'-20'	20'	Central Leader, Symmetrical & Full
ORNAN	IENTAL & SMALL TREES									
SYM.	Botanical Name	Common Name		Quantity	Units	Size	Cal.	Height	Spread	Remarks
ID	llex decidua 'Walter'	Possumhaw	-	3	EA	45 gal.	2 1/2"	8-10'	4-5'	Full plants rooted to container
IV	llex vomitoria	Yaupon Holly (Upright)	-	5	EA	45 gal.	2 1/2"	8-10'	4-5'	Full plants rooted to container
SP	Sophora secundiflora	Texas Mountain Laurel	-	3	EA	45 gal.	2 1/2"	8-10'	4-5'	Full plants rooted to container
				4.4		45 gal.	2 1/2"	8-10'	4-5'	Full plants rooted to container
VR	Viburnum rufidulum	Rusty Blackhaw Viburnum	-	11	EA	45 yai.	2 172	0.10		
I	Viburnum ruhdulum IENTAL MIX - A Botanical Name	Common Name	- % of mix	Quantity	Units	43 gai.			1	
ORNAN	IENTAL MIX - A		- % of mix 15%]]		-	Height	Spread 18"	Spacing 18"	Remarks
ORNAN	IENTAL MIX - A Botanical Name	Common Name		Quantity	Units	Size	Height	Spread	Spacing	
ORNAN	IENTAL MIX - A Botanical Name Aristida purpurea	Common Name Purple Threeawn	15%	Quantity 330	Units EA	Size 1 gal.	Height 18"	Spread 18"	Spacing 18"	Remarks Full plants rooted to container
ORNAN	IENTAL MIX - A Botanical Name Aristida purpurea Bouteloua gracilis	Common Name Purple Threeawn Blue Grama	15% 10%	Quantity 330 222	Units EA EA	Size 1 gal. 1 gal.	Height 18" 18"	Spread 18" 18"	Spacing 18" 18"	Remarks Full plants rooted to container Full plants rooted to container
ORNAN SYM.	IENTAL MIX - A Botanical Name Aristida purpurea Bouteloua gracilis Elymus canadensis	Common Name Purple Threeawn Blue Grama Canada Wild Rye	15% 10% 15%	Quantity 330 222 330	Units EA EA EA	Size 1 gal. 1 gal. 1 gal.	Height 18" 18" 18"	Spread 18" 18" 18"	Spacing 18" 18" 18"	Remarks Full plants rooted to container Full plants rooted to container Full plants rooted to container
ORNAN SYM.	IENTAL MIX - A Botanical Name Aristida purpurea Bouteloua gracilis Elymus canadensis Malvaiscus arboreus	Common Name Purple Threeawn Blue Grama Canada Wild Rye Turk's Cap	15% 10% 15% 15%	Quantity 330 222 330 187	Units EA EA EA EA	Size 1 gal. 1 gal. 1 gal. 5 gal.	Height 18" 18" 18" 24"	Spread 18" 18" 18" 24"	Spacing 18" 18" 18" 24"	Remarks Full plants rooted to container Full plants rooted to container Full plants rooted to container Full plants rooted to container
ORNAN SYM.	Aristida purpurea Aristida purpurea Bouteloua gracilis Elymus canadensis Malvaiscus arboreus Muhlenbergia lindheimeri	Common Name Purple Threeawn Blue Grama Canada Wild Rye Turk's Cap Lindheimer's Muhly	15% 10% 15% 15% 15%	Quantity 330 222 330 187 118	Units EA EA EA EA EA	Size 1 gal. 1 gal. 1 gal. 5 gal. 1 gal.	Height 18" 18" 18" 24" 18"	Spread 18" 18" 18" 24" 15"	Spacing 18" 18" 18" 24" 30"	Remarks Full plants rooted to container Full plants rooted to container Full plants rooted to container Full plants rooted to container Full plants rooted to container

ORNAMENTAL MIX - B

SYM.	Botanical Name	Common Name	% of mix	Quantity	Units	Size	Height	Spread	Spacing	Remarks
	Bouteloua gracilis	Blue Grama	20%	382	EA	1 gal.	18"	18"	18''	Full plants rooted to container
	Chasmanthium latifolium	Inland Sea Oats	15%	160	EA	1 gal.	15"	12"	24"	Full plants rooted to container
	Elymus canadensis	Canada Wild Rye	15%	285	EA	1 gal.	18"	18"	18''	Full plants rooted to container
ОМВ	Muhlenbergia dumosa	Bamboo Muhly	10%	45	EA	5 gal.	30"	36"	36"	Full plants rooted to container
	Muhlenbergia reverchonii	Seep Muhly	15%	285	EA	1 gal.	18"	18"	18''	Full plants rooted to container
	Sabal minor	Dwarf Palmetto	10%	45	EA	5 gal.	36"	36"	36''	Full plants rooted to container
	Schizachyrium scoparium 'The Blues'	Little Bluestem 'The Blues'	15%	160	EA	1 gal.	20"	15"	24"	Full plants rooted to container
			100%							

FILTER STRIP MIX - A SYM. Botanical Name

	Aristida purpl
	Bouteloua cu
	Bouteloua da
FMA	Chasmanthiu
	Coreopsis lin
	Elymus cana
	Schizachyriu

FILTER	R STRIP MIX - B
SYM.	Botanical Nan
	Bouteloua curt
	Elymus canad
	Gaura lindhein
FMB	Hilaria belange
	Solidago altiss
	Salvia greggii
	Schizachyrium

PLANT MIX QUANTITES BY BED

ORNAMENTAL MIX-A

v	MANIENTAE IMA'A													
Spacing	%	Botanical Name	Common Name	Size	Total	OMA-1	OMA-2	OMA-3	OMA-4	OMA-5	OMA-6	OMA-7	OMA-8	OMA-9
18"	15%	Aristida purpurea	Purple Threeawn	1 gal.	330	40	37	92	48	10	23	5	10	65
18"	10%	Bouteloua gracilis	Blue Grama	1 gal.	222	27	25	62	32	6	15	4	7	44
18"	15%	Elymus canadensis	Canada Wild Rye	1 gal.	330	40	37	92	48	10	23	5	10	65
24"	15%	Malvaiscus arboreus	Turk's Cap	5 gal.	187	23	21	52	27	5	13	3	6	37
30"	15%	Muhlenbergia lindheimeri	Lindheimer's Muhly	1 gal.	118	14	13	33	17	3	8	2	4	24
24"	15%	Panicum virgatum 'Shenandoah'	Switchgrass 'Shenandoah'	1 gal.	187	23	21	52	27	5	13	3	6	37
24"	15%	Schizachyrium scoparium 'The Blues'	Little Bluestem 'The Blues'	1 gal.	187	23	21	52	27	5	13	3	6	37
		Total			1,561	190	175	435	226	44	108	25	49	309
	100%													

Area

ORNAMENTAL MIX-B

Spacing	%	Botanical Name	Common Name	Size	Total	OMB-1	OMB-2	OMB-3	OMB-4	OMB-5	OMB-6
18"	20%	Bouteloua gracilis	Blue Grama	1 gal.	382	110	118	25	16	54	59
24"	15%	Chasmanthium latifolium	Inland Sea Oats	1 gal.	160	46	49	10	7	23	25
18"	15%	Elymus canadensis	Canada Wild Rye	1 gal.	285	82	88	19	12	40	44
36"	10%	Muhlenbergia dumosa	Bamboo Muhiy	5 gal.	45	13	14	3	2	6	7
18"	15%	Muhlenbergia reverchonii	Seep Muhly	1 gal.	285	82	88	19	12	40	44
36"	10%	Sabal minor	Dwarf Palmetto	5 gal.	45	13	14	3	2	6	7
24"	15%	Schizachyrium scoparium 'The Blues'	Little Bluestem 'The Blues'	1 gal.	160	46	49	10	7	23	25
		Total			1,362	392	420	89	58	192	211
			•	•	•	-				•	

100% Area

FILTER STRIP MIX-A

•											
Spacing	%	Botanical Name	Common Name	Size	Total	FMA-1	FMA-2	FMA-3	FMA-4	FMA-5	FMA-6
18"	15%	Aristida purpurea	Purple Threeawn	1 gal.	139	8	26	10	67	10	18
18"	10%	Bouteloua curtipendula	Sideoats Grama	1 gal.	94	6	17	7	45	7	12
12"	15%	Bouteloua dactyloides	Buffalo Grass	1 gal.	321	19	60	23	154	23	42
24"	15%	Chasmanthium latifolium	Inland Sea Oats	1 gal.	79	5	15	6	37	6	10
18"	15%	Coreopsis linifolia	Texas Tickseed	1 gal.	139	8	26	10	67	10	18
18"	15%	Elymus canadensis	Canada Wild Rye	1 gal.	139	8	26	10	67	10	18
24"	15%	Schizachyrium scoparium	Little Bluestern 'The Blues'	1 gal.	79	5	15	6	37	6	10
		Total			990	59	185	72	474	72	128

100%

Area

FILTER STRIP MIX-B

Spacing	%	Botanical Name	Common Name	Size	Total	FMB-1	FMB-2	FMB-3
18"	20%	Bouteloua curtipendula	Sideoats Grama	1 gal.	165	91	62	12
18"	15%	Elymus canadensis	Canada Wild Rye	1 gal.	124	68	47	9
24"	15%	Gaura lindheimeri	Gaura 'Whirling Butterflies'	1 gal.	69	38	26	5
12"	10%	Hilaria belangeri	Curly Mesquite	1 gal.	189	104	72	13
18"	15%	Solidago altissima	Late Goldenrod	1 gal.	124	68	47	9
24"	10%	Salvia greggii	Autumn Sage	1 gal.	45	25	17	3
24"	15%	Schizachyrium scoparium 'The Blues'	Little Bluestem 'The Blues'	1 gal.	69	38	26	5
		Total			785	432	297	56
	100%							

100%

Area

me	Common Name	% of mix	Quantity	Units	Size	Height	Spread	Spacing	Remarks
urea	Purple Threeawn	15%	139	EA	1 gal	18"	18"	18"	Full plants rooted to container
rtipendula	Sideoats Grama	10%	94	EA	1 gal	18"	18"	18"	Full plants rooted to container
ctyloides	Buffalo Grass	15%	321	EA	1 gal.	12"	12"	12"	Full plants rooted to container
m latifolium	Inland Sea Oats	15%	79	EA	1 gal.	15"	12"	24"	Full plants rooted to container
ifolia	Texas Tickseed	15%	139	EA	1 gal.	15"	18"	18"	Full plants rooted to container
densis	Canada Wild Rye	15%	139	EA	1 gal.	18"	18"	18"	Full plants rooted to container
m scoparium 'The Blues'	Little Bluestem 'The Blues'	15%	79	EA	1 gal.	20"	15"	24"	Full plants rooted to container
		100%							

me	Common Name	% of mix	Quantity	Units	Size	Height	Spread	Spacing	Remarks
rtipendula	Sideoats Grama	20%	165	EA	1 gal	18"	18"	18''	Full plants rooted to container
densis	Canada Wild Rye	15%	124	EA	1 gal	18"	18"	18''	Full plants rooted to container
meri	Gaura 'Whirling Butterflies'	15%	69	EA	1 gal.	18"	18"	24"	Full plants rooted to container
ie ri	Curly Mesquite	10%	189	EA	1 gal.	12"	12"	12"	Full plants rooted to container
sima	Late Goldenrod	15%	124	EA	1 gal.	24"-48"	12"	18"	Full plants rooted to container
	Autumn Sage	10%	45	EA	1 gal.	24"	24"	24"	Full plants rooted to container
m scoparium 'The Blues'	Little Bluestem 'The Blues'	15%	69	EA	1 gal.	20"	15"	24"	Full plants rooted to container
		100%			•				

4414 536 493 1232

 3804
 1099
 1178
 248
 158
 536
 585

127

891 135 244

305

70

645

1864 113 347 134

623 115 1646 908

BRACKENRIDGE PARK

SAN ANTONIO, TX

CLIENT: CITY OF SAN ANTONIO PUBLIC WORKS DEPARTMENT (TCI) PO BOX 839966, SAN ANTONIO TX 78283-3966

LANDSCAPE ARCHITECT



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LUNDY & FRANKE ENGINEERING STRUCTURAL ENGINEER 549 HEIMER SAN ANTONIO, TX 78232

INTELLIGENT ENGINEERING SERVICES C**IVIL ENGINEER** 1045 CENTRAL PARKWAY NORTH, SUITE 200, SAN ANTONIO, TX 78232

TRUE NORTH CONSULTING GROUP IT AND COMMUNICATIONS 13284 POND SPRINGS ROAD, STE. 304 AUSTIN TX, 78729

CNG ENGINEERING MEP

1917 N. NEW BRAUNFELS AVE., SUITE 201, SAN ANTONIO TX, 78208

WGI ENGINEERING HYDROLOGY 5710 W HAUSMAN RD. SAN ANTONIO, TX 78249

Stamp



Revisions

134 872

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Date 11 JANUARY 2023 Phase 95% CONSTRUCTION DOCUMENTS Job Number CNOS701

Scale

North

Drawing Title

PLANTING SCHEDULE

Drawing Number

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MEP 1917 N. NEW BRAUNFELS AVE., SUITE 201, SAN ANTONIO TX, 78208

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HYDROLOGY 5710 W HAUSMAN RD. SAN ANTONIO, TX 78249

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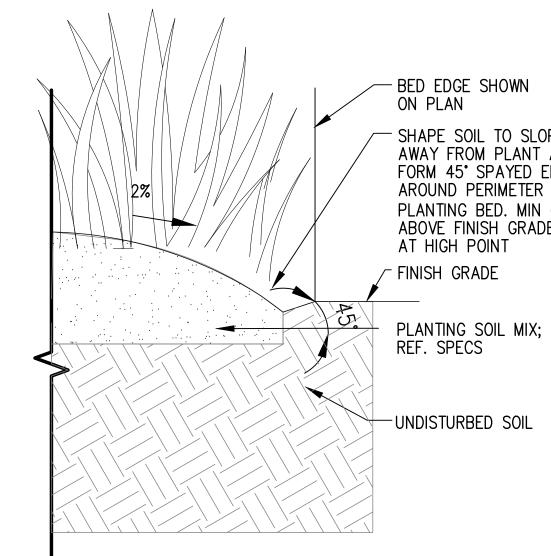


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Date 11 JANUARY 2023 Phase 95% CONSTRUCTION DOCUMENTS Job Number CNOS701						
Scale	North					
) 8' 16' _{/16} " = 1'-0"						
Drawing Title						
PLANTING PLAN						
Drawing Number						

NOTES

- 1. REF. L5.00 PLANT SCHEDULE FOR SPECIES, MIXES, AND QUANTITIES.
- 2. REF. L6.01 PLANTING DETAILS FOR STANDARD TREE, SHRUB, AND PERENNIAL/GRASS PLANTING INSTALL.
- 3. TREE LAYOUT TO BE APPROVED BY LANDSCAPE ARCHITECT IN FIELD.
- 4. MIX LAYOUT TO BE APPROVED BY LANDSCAPE ARCHITECT IN FIELD PRIOR TO PLANTING.






PLAN – TYPICAL TREE STAKING


(06)

3/4" = 1'-0"

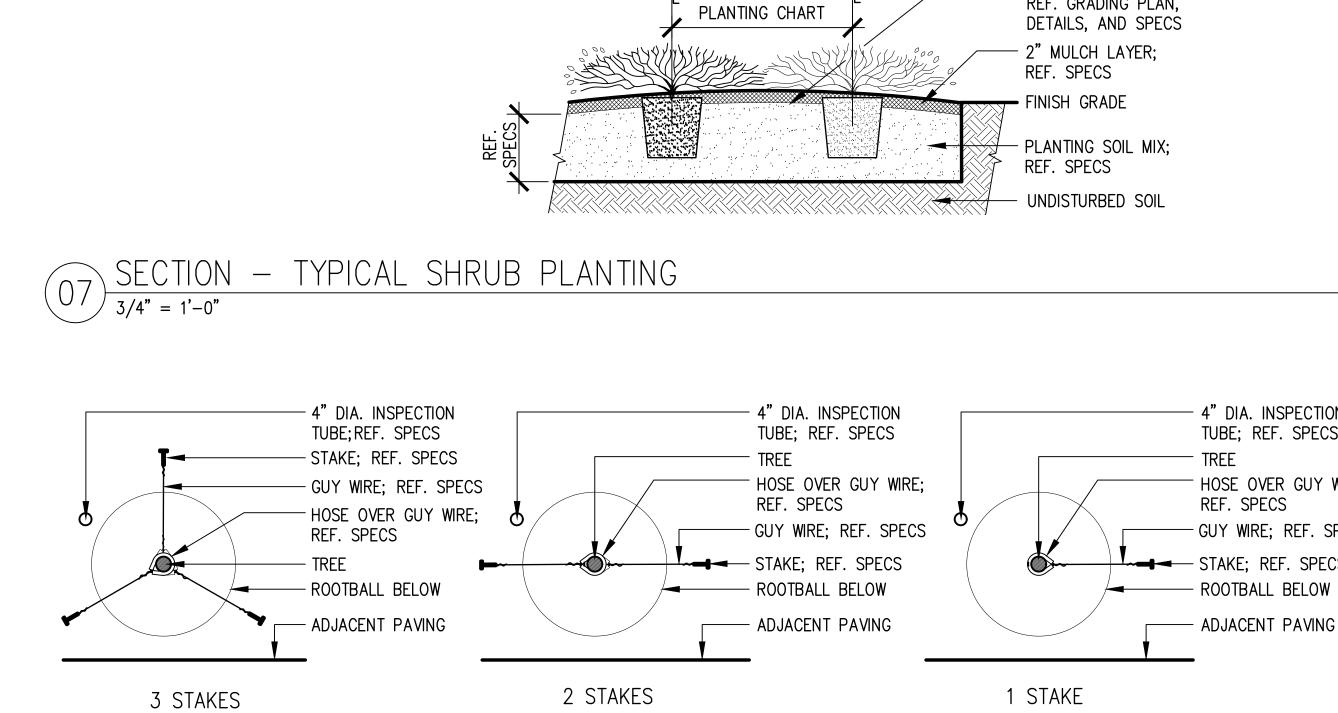

SPACING PER

- 4" DIA. INSPECTION TUBE; REF. SPECS HOSE OVER GUY WIRE; - GUY WIRE; REF. SPECS - STAKE; REF. SPECS — ADJACENT PAVING

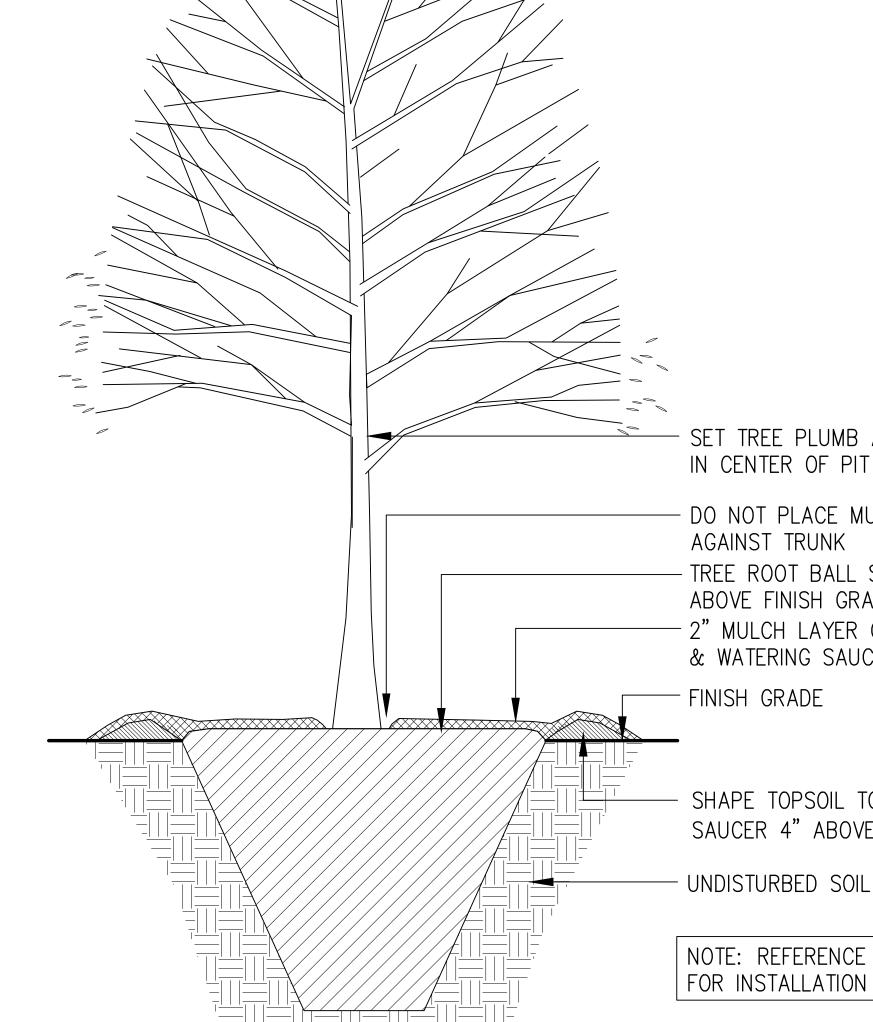

SET TREE PLUMB AND IN CENTER OF PIT - DO NOT PLACE MULCH AGAINST TRUNK - TREE ROOT BALL SET 3" ABOVE FINISH GRADE 2" MULCH LAYER OVER ROOTBALL & WATERING SAUCER - FINISH GRADE

- CROWN BED;

REF. GRADING PLAN,

- SHAPE SOIL TO SLOPE AWAY FROM PLANT AND FORM 45' SPAYED EDGE AROUND PERIMETER OF PLANTING BED. MIN 6" ABOVE FINISH GRADE AT HIGH POINT - FINISH GRADE

2 $\overrightarrow{}$

 $(05) \frac{\text{PLAN} - \text{PLANT SPACING CHART}}{3" = 1'-0"}$

LOCATION PAVING EDGE, ─6" FOR GROUNDCOVERS BUILDING OR CURB -15" FOR SHRUBS

<u>PLANTS / SF</u> 4.61 2.60 1.78 1.66 1.15 .738 .50 .28 .18 .12 .07 .04 72" 0.C. .03

NOTE: DIMENSION 'S' DENOTES PLANT SPACING AS CALLED OUT ON PLANT LIST. TYP. PLANT

6" O.C. 8" O.C. 9" O.C. 10" O.C. 12" O.C. 15" O.C. 18" O.C. 24" O.C. 30" O.C. 36" O.C. 48" O.C. 60" O.C.

- PIVOT SHRUBS AT

- TYP. SHRUB PLANTING

- LIMIT OF SHRUBS OR

HEADER-WHERE OCCURS

- ROW LINE- ALIGN ALL

SHRUBS IN ROW LINES

OF ROW LINES OR AT

ENDS OF SHRUB ROW

FOR SINGLE ROW OF SHRUBS, CENTER SHRUB IN ROW LINE

BETWEEN LIMITS OF SHRUBS

L= SPACING AS CALLED

FOR IN PLANTING PLAN


NOTE:

INTERSECTION OF ROW LINES

<u>SPACING</u>

SECTION - MACHINE MOVED TREE PLANTING

SECTION - TYPICAL TREE PLANTING $(01) \frac{\text{SECHON}}{1/2" = 1'-0"}$

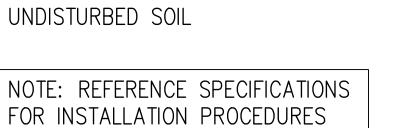


SAUCER 4" ABOVE FINISH GRADE

SHAPE TOPSOIL TO FORM WATERING

- SET TREE PLUMB AND IN CENTER OF PIT - FABRIC TREE TIE; REF. SPECS. TREE STAKE. REF. SPECS. ω - DO NOT PLACE MULCH AGAINST TRUNK TREE ROOT BALL; SET 2" ABOVE FINISH GRADE OR AS SPEC. ⁻ 2" MULCH LAYER OVER ROOTBALL & WATERING SAUCER TOPSOIL SHAPED TO FORM WATERING SAUCER 3" ABOVE FINISH GRADE 2 STAKES) 3 STAKES) — FINISH GRADE - BACKFILL MIX - UNDISTURBED SOIL ¥ 2' (TYP. 3' (TYP. NOTE: REFERENCE - FILTER FABRIC SPECIFICATIONS FOR MATERIALS

SECTION - TYPICAL MULTI-TRUNK TREE PLANTING $(02) \frac{\text{SEC IION}}{1/2" = 1'-0"}$

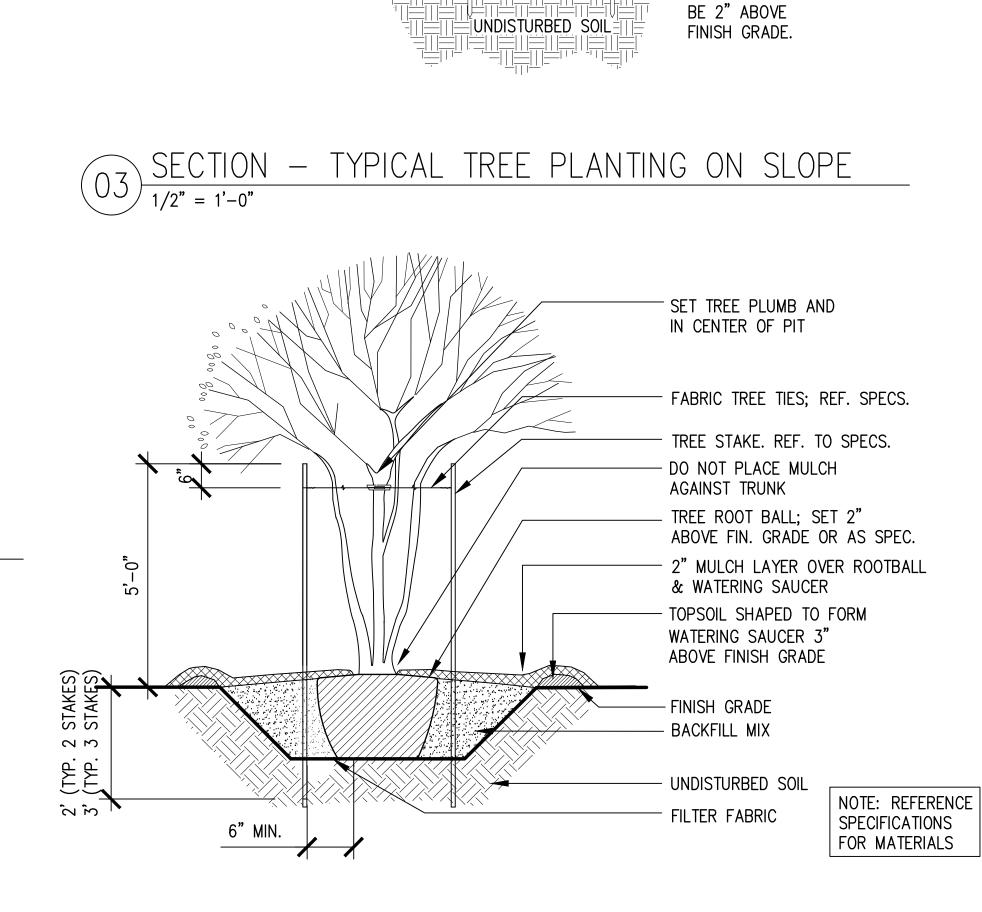

"INFILL SHRUB" AT INTERSECTION

TREE STAKE. REF TO SPECS. 3" EARTH SAUCER

TREE PIT SNUG AROUND-

ROOTBALL

- DO NOT PLACE MULCH AGAINST TRUNK

MULCH BACKFILL WITH PARENT MATERIAL

- ROOTBALL SHALL

TREE TIES. REF. TO SPECS.

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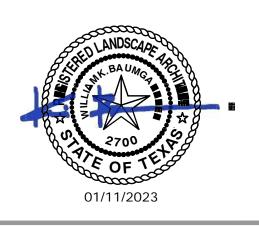
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Date
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95% CONSTRUCTION DOCUMEN
Job Number
CNOS701

Scale

Drawing Title

PLANTING DETAILS

L6.01

Drawing Number

00 -00 03– 3RS1 NO. BR ECT NO.: PROJ FILE Z Z DEMOLITION NOTES:

STRUCTURES.

<u>DN-1</u> THE CONTRACTOR MUST REVIEW ALL WORK IN PROGRESS TO ASCERTAIN THAT ACTUAL STRUCTURAL CONDITIONS ENCOUNTERED REFLECT THOSE SHOWN ON THE DRAWINGS, AND REPORT ANY DISCREPANCIES TO THE STRUCTURAL ENGINEER.

<u>DN-2</u> DURING DEMOLITION CONTRACTOR SHALL IDENTIFY STRUCTURAL FRAMING AND LOAD PATHS IN AREA OF DEMOLITION TO PREVENT ACCIDENTAL COLLAPSE. <u>DN-3</u> CONTRACTOR SHALL BE RESPONSIBLE FOR PROVIDING ALL BRACING AND SHORING REQUIRED TO INSURE THE SAFETY AND STRUCTURAL INTEGRITY OF THE

PROJECT DURING DEMOLITION OPERATIONS. DN-4 CONTRACTOR SHALL INSPECT EXISTING STRUCTURAL ELEMENTS AND REPAIR

OR REPLACE THOSE FOUND TO BE STRUCTURALLY UNSOUND AS DIRECTED BY STRUCTURAL ENGINEER OF RECORD. DN-5 WHERE EXISTING CONCRETE IS NOTED TO BE REMOVED, WORK SHALL BE

INITIATED BY MEANS OF SAW CUTS AT LEAST 1" DEEP OR BY PERFORATING WITH CLOSELY SPACED THRU-DRILLED HOLES. IF REINFORCING IS TO REMAIN, INITIATE WITH SAW CUTS APPROXIMATELY 3/4" DEEP. DEMOLITION SHALL PROCEED USING HAND HELD ROTARY TOOLS AND/OR LOW IMPACT CHIPPING DEVICES. NO JACK HAMMERS OR SIMILAR HEAVY IMPACT EQUIPMENT WILL BE PERMITTED.

<u>DN-6</u> INITIATE SAWCUTTING THRU WALLS AND SLABS WITH 3" CORE HOLES AT ALL CORNERS TO PREVENT OVERCUTS. OVERCUTS ARE NOT PERMITTED.

<u>DN-7</u> REPLACE ALL CONCRETE COVERAGE, REMOVED TO INSTALL NEW STEEL MEMBERS, TO MAINTAIN FIRE PROTECTION OF MAIN STRUCTURAL FRAMING. <u>DN-8</u> ALL TEMPORARY SHORING IS TO BE DESIGNED AND DETAILED BY A LICENSED PROFESSIONAL ENGINEER. SIGNED AND STAMPED DRAWINGS ARE TO BE SUBMITTED TO THE A/E TEAM FOR REVIEW AND APPROVAL PRIOR TO FABRICATION AND

CONSTRUCTION. <u>DN-9</u> SELECTIVE DEMO OF HISTORIC STRUCTURES EXISTS WITHIN PROJECT SCOPE. CARE TO BE TAKEN TO PRESURE BOTH OUT OF SCOPE STRUCTURES & DEMO MATERIALS FOR PRESERVATION & REUSE.

<u>DN-10</u> NO HEAVY MACHINERY OR VEHICLES ARE PERMITTED NEAR HISTORICAL STRUCTURES UNLESS ABSOLUTELY REQUIRED BY CONSTRUCTION SEQUENCING. <u>DN-11</u> CONTRACTOR TO PRESERVE AS MUCH HISTORIC STONE AS POSSIBLE FOR REINTEGRATION INTO RECONSTRUCTION AND REHABILITATION OF EXTANT HISTORIC

<u>CONCRETE N</u>								<u>GENERAL NOTES:</u>
COMPRESSIV	RETE SHALL BE E STRENGTHS A , CEMENT, ADM	S GIVEN E	BELOW. RI					<u>GN-1</u> THIS STRUCTURE IS DESIGNED IN ACCORDANCE WITH THE INTERNATIONAL BUILDING CODE (2021) AS AMENDED AND ADOPTED BY THE GOVERNING AUTHORITY, AND APPLICABLE INDUSTRY STANDARDS (AISC, ACI, ETC.).
COLUMNS AN	ND WALLS	• • • • •			. 4,000) PSI		<u>GN-2</u> THE DESIGN LOADS ARE:
	ASH WILL BE F PECIFICATIONS.	PERMITTED	UP TO 20	% PORTLANI	D CEMEN	NT REPLA	ACEMENT,	MECHANICAL DUCTS/CONDUITS, CEILING, ETC
<u>CN-2</u> REINFORCING STEEL SHALL BE FROM NEW BILLET AND SHALL CONFORM TO THE FOLLOWING ASTM SPECIFICATIONS:						L CONFO	MECHANICAL EQUIPMENT AS INDICATED ON PLANS	
A185	D			. WELDED V	VIRE FAB	BRIC		CORRIDOR
A615-GR 60	D D -60T		Α	LL OTHER F	REINFORC	CING		MECHANICAL ROOMS
ASTM A496			DE	FORMED BAI	R ANCHO	DRS	HALL BE	ASSEMBLY AREAS: FIXED SEATS
IN ACCORDA	NCE WITH LATES CONCRETE STR	ST ACI MAN RUCTURES	NUAL OF S (ACI 315).	TANDARD PI BAR SUP	RACTICE PORTS S	FOR DET	TAILING AVE	LOBBIES
	NTED LEGS OR							CATWALKS
SHALL BE L	"CORNER DETA APPED 1-1/2	TURNS. W	ELDED WIF	RE MESH SH	IALL BE	LAPPED		FLAT ROOF 20 PSF PITCHED ROOF 20 PSF
<u>CN-5</u> CONT	SPLICE POINTS	PROVIDE N	IECESSARY	CONSTRUC	FION JOI	NTS IN		ROOF SNOW LOAD GROUND SNOW Pg
POURED IN	CONCRETE FOR ONE DAY. LOC OF STRUCTURAL	ATION OF	CONSTRUC	TION JOINTS	6 MUST	HAVE PR	RIOR	SNOW EXPOSURE FACTOR Ce 1.0 SNOW LOAD IMPORTANCE FACTOR IS 1.1 THERMAL FACTOR Ct
CONTINUOUS	OR NEAR MID- REINFORCING UOUS KEY BETV	SHALL BE	CARRIED T	HROUGH TH				WIND LOAD BASIC WIND SPEED (ULTIMATE DESIGN)
	ARCHITECTURAL,)N AND SIZES (NGS	BUILDING CATEGORY
ANCHORS AN	ND BOLTS REQU	JIRED BY A	BOVE.		·	·		COMPONENTS AND CLADDING WIND PRESSURE 25 PSF
AND LOCATIO	R TO ARCHITECT DNS OF SLAB D	ROPS AND	DEPRESS	ONS.				EARTHQUAKE LOADS SEISMIC IMPORTANCE FACTOR IE 1.00 SPECTRAL RESPONSE ACCELERATION Ss
TOP LAYER OF 1-1/2"	ANICAL AND EL OF SLAB REINF CLEAR BETWEEI	ORCING OF N INDIVIDU	R WELDED AL CONDUI	WIRE FABRIO TS, AND BE	C. PRO	VIDE A N	MINIMUM	SPECTRAL RESPONSE ACCELERATION S 3% SPECTRAL RESPONSE COEF. SDs. 14% SPECTRAL RESPONSE COEF. SD 5%
PARALLEL R	EINFORCING. D	O NOT "BL	JNDLE" CO	NDUITS.				SEISMIC DESIGN CATEGORY
WITH UPSET	ENDS, AUTOMA	TICALLY AR	RC WELDED					RETAINING WALLS GLOBAL STABILITY ANALYSIS FACTOR OF SAFETY 1.5 TYPE
	NICAL TESTING OF				PRODUC	TION WEI	DING	EQUIVALENT FLUID PRESSURE
AND AF IS SATI	TER ANY EQUIPM SFACTORY. THEY	IENT MAINTE MAY ALSO	ENANCE TO BE MADE D	ENSURE THA	T THE W	ELDING S ION RUN	CHEDULE OR AT	FOOTING BEARING
CHANGE BE DOM		STUDS ARE THE STUD N	e tested b With a ham	y bending t Mer or by	'HE STUD BENDING	. BENDIN	G MAY G A	FLOOD LOAD ELEVATION OF LOWEST FLOOR
WELD F	BE DONE BY STRIKING THE STUD WITH A HAMMER OR BY BENDING IT USING A TUBE OR PIPE, THE ANGLE THROUGH WHICH THE STUD WILL BEND WITHOUT WELD FAILURE WILL DEPEND ON THE STUD AND BASE METAL COMPOSITIONS, CONDITIONS (COLD WORKED, HEAT TREATED), AND STUD DESIGN, ACCEPTABLE						,	<u>GN-3</u> ALLOWABLE STRESS DESIGN LOAD COMBINATIONS (FOR ALL DESIGNS EXCEPT CONCRETE)
BENDIN ESTABL	CONDITIONS (COLD WORKED, HEAT TREATED), AND STUD DESIGN. ACCEPTABLE BENDING SHOULD BE DETERMINED WHEN THE WELDING PROCEDURE SPECIFICATION IS ESTABLISHED OR FROM THE APPLICABLE WELDING CODE. BEND TESTING MAY DAMAGE THE STUD; THEREFORE, IT SHOULD BE DONE ON QUALIFICATION SAMPLES						CATION IS MAY	D D+L
ONLY. DEPENI	THE METHOD USI ON THE STUD PROPERLY WITHOU	ED TO APPL DESIGN. SP	Y TENSILE ECIAL TOOL	LOAD ON AN ING MAY BE	ARC WE	LDED STU D TO GRI	JD WILL IP THE	D+(Lr, or S or R) D+0.75L+0.75(Lr, or S or R) D+(0.6W)
NEEDED		JI DAMAGE,	AND A SP	LOAL LOADIN	G DEVICE	L MAIDL		D+0.75L+0.75(0.6W)+0.75(Lr or S or R) 0.6D+0.6W
MECHAN	NICAL TESTING OF	ll be madi	E IN THE F					D+0.7E STRENGTH DESIGN LOAD COMBINATIONS (FOR CONCRETE DESIGN)
50 PLA CONFIG	ETE. THE CONTR TES OF EACH TO URATION PLATES	PE OR ADD	NTIONAL STU ERS, THESE	JDS SHALL E STUDS SHA	BE PLACE LL BE TE	d on Sp Sted in	ECIAL THE	1.4D 1.2D+1.6L+0.5(Lr, or S or R)
DONE E OR PIP	arc welded stu By striking the 'E. The angle ti	STUD WITH HROUGH WH	A HAMMER IICH THE ST	OR BY BEN UD WILL BEI	NDING IT ND WITHC	USING A DUT WELD	TUBE FAILURE	1.2D+1.6(Lr, or S or R)+(L or 0.5W) 1.2D+1.0W+L+0.5(Lr, or S or R)
WORKE	EPEND ON THE S D, HEAT TREATED MAY NOT BE USE), AND STU	D DESIGN.	BEND TESTIN	IG MAY D)AMAGE, Ť		0.9+1.0W 1.2D+E+L+0.2S
ARC W	CATION SAMPLES ELDED STUD WILI E, AND A SPECIA	_ DEPEND (ON THE STU	D DESIGN. F	PROPERLY			<u>GN-4</u> PRIOR TO START OF CONSTRUCTION, THE CONTRACTOR AND FABRICATOR SHALL VERIFY ALL QUANTITIES, DIMENSIONS AND CONDITIONS AND NOTIFY ARCHITECT/STRUCTURAL ENGINEER OF RECORD OF ANY DISCREPANCIES BEFORE
	ER TO SPECIFIC							PROCEEDING WITH THE WORK. <u>GN-5</u> UTILITIES PENETRATING BUILDING SHALL BE FLEXIBLE, USING SLEEVE JOINTS,
OF THE HOS		0.000	13 03ED,			.		BENDS, LOOPS, ETC. TO PERMIT MOVEMENTS DUE TO EXPANSIVE UNDERLYING SOILS.
								<u>GN-6</u> PROVIDE ADEQUATE AND APPROPRIATE STRUCTURAL STEEL FRAMING FOR THE SUPPORT AND MOUNTING OF MECHANICAL EQUIPMENT RESTING ON, OR SUSPENDED
								FROM, STEEL SUPERSTRUCTURE. <u>GN-7</u> THE STRUCTURAL DRAWINGS FOR THIS PROJECT ARE COPYRIGHTED AND
RFI	NFORCING E	SAR I AP	SPLICE	TARI F		NRY)		SHALL NOT BE REPRODUCED FOR USE AS FABRICATOR'S ERECTION DRAWINGS. THE CONTRACTOR SHALL ALLOW ADEQUATE TIME AND EXPENSE FOR SUBCONTRACTORS TO PRODUCE THEIR OWN ORIGINAL ERECTION AND PLACEMENT
BAR		COI	NCRETE	f'c (PSI)			CLASS	DRAWINGS. <u>GN-8</u> THE STRUCTURE HAS BEEN DESIGNED TO RESIST DESIGN LOADS ONLY AS A
SIZE	POSITION	2500 В	3000 B					COMPLETED STRUCTURE. ANY PROPOSED APPLICATION OF CONSTRUCTION LOADS OR OF ANY LOADS TO THE PARTIALLY COMPLETED STRUCTURE WHICH EXCEED THE DESIGN LOADS WILL REQUIRE REANALYSIS AND PROBABLE REDESIGN.
#3 thru #6	ALL	40db	40db					
#7 thru #11	ALL	72db	72db					
REINFORG	CING BAR L <i>i</i>							
BAR SIZE	POSITION	3000	A000	f'c (PSI) 5000) AND 6000			<u>UNDERFLOOR FILL NOTES:</u> <u>UF-1</u> BEFORE ANY CONSTRUCTION IS BEGUN, PERFORM ROUGH GRADING AND CUT
	ALL	B 74db	B 64db	B 58db	B 50db			SWALES SO THAT GROUNDS WILL DRAIN AWAY FROM THE BUILDING. MAINTAIN DRAINAGE DURING ALL PHASES OF CONSTRUCTION SO THAT STORM WATER WILL BE CONDUCTED AWAY FROM THE BUILDING. KEEP EXCAVATIONS PUMPED FREE OF STORM WATER AT ALL
#3 thru #6 #7 thru #11	ALL	93db	80db	72db	60db			TIMES. <i>UF-2</i> PRECAUTIONS SHALL BE TAKEN TO PROTECT OPEN EXCAVATIONS FROM EXCESSIVE
	RCING BAR I	AP SPI	ICF TAF	 F (SI Δ	BS AN	⊔ D W≬I		LOSS OR GAIN IN NATURAL MOISTURE LEVEL PRIOR TO PLACEMENT OF BASE MATERIAL. KEEP MOIST DURING DRY WEATHER AND KEEP STORM WATER PUMPED OUT, INCLUDING NIGHTS AND WEEKENDS, DURING RAINS.
		•		f'c (PSI)				UF-3 IN THE AREA OCCUPIED BY THE FOUNDATION AND ALL ADJACENT SIDEWALKS, PLUS
BAR SIZE	POSITION	3000 B	4000 B	5000 B				3'-0", REMOVE A MINIMUM OF 3'-0" OF TOPSOIL INCLUDING ALL ORGANIC MATERIALS, ROOTS, ETC. FROM THE SITE. DO NOT USE FOR UNDERFLOOR FILL. REMOVE ADDITIONAL MATERIAL AS NECESSARY TO PROVIDE A MINIMUM OF 3'-0" OF SELECT FILL
		75db	64db	58db				AS PER UF-6. <i>UF-4</i> THE RESULTING SURFACE SHALL BE PROOF ROLLED WITH A SUFFICIENTLY HEAVY
#3 thru #6	0.75" COVER 2.0" COVER 0.75" COVER	75db 46db 138db	40db	58db 40db 106db				ROLLER (15 TONS) TO LOCATE AND DENSITY WEAK AND COMPRESSIBLE ZONES. A MINIMUM OF 6 PASSES OF THE ROLLER IS REQUIRED. ANY SOFT SPOTS SHALL BE
#7 thru #11	2.0" COVER	74db	65db	56db				REMOVED AND REPLACED WITH COMPACTED SELECT FILL. <u>UF-5</u> THE ROLLED SUBGRADE SHALL BE SCARIFIED JUST PRIOR TO FILL PLACEMENT TO
		 :e.				<u> </u>		A MINIMUM DEPTH OF 6" AND RECOMPACTED TO MINIMUM OF 95% OF THE MAXIMUM DENSITY DETERMINED BY ASTM D698 COMPACTION TEST, MAINTAINING MOISTURE CONTENT BETWEEN -1 AND $+3$ PERCENTAGE POINTS UNTIL COVERED.
-	<u>.ICE TABLE NOTE</u> NOTES BAR DIA	_						<u><i>UF-6</i></u> FOR A DISTANCE OF $3'-0''$ OUTSIDE OF THE BUILDING LINE AND ALL ADJACENT SIDEWALKS, AND BEGINNING AT THE LOW END, BUILD UP TO THE ELEVATION OF THE
<u>RL-2</u> ALL SPL	LICES SHALL BE	CLASS B	UNLESS (THERWISE I	NOTED.			SIDEWALKS, AND BEGINNING AT THE LOW END, BUILD OP TO THE ELEVATION OF THE BOTTOM OF THE SLAB WITH SELECT CRUSHED STONE FILL CONFORMING TO TXDOT SPECIFICATIONS, ITEM 247, TYPE "A" GRADE 2. A MINIMUM THICKNESS OF 3'-0" IS

<u>*RL-3*</u> VALUES APPLY TO ALL BARS WITH MINIMUM CONCRETE COVER 1.0db AND MINIMUM CENTER TO CENTER SPACING OF 2.0db. RL-4 FOR LIGHTWEIGHT CONCRETE, MULTIPLY BY 1.3.

<u>RL-5</u> THE CHART ABOVE IS A SIMPLIFIED AND CONSERVATIVE METHOD FOR MEETING THE REQUIREMENTS OF ACI 12.2.2. THE CONTRACTOR MAY SUBMIT A DETAILED REBAR SPLICING PLAN IN ACCORDANCE WITH ACI 12.2.2 FOR APPROVAL.

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CONTRACTOR NOTE

<u>UF-7</u> ALL FILL SHALL BE PLACED IN 8" LOOSE HORIZONTAL LIFTS AND COMPACTED TO A MINIMUM OF 95% OF THE MAXIMUM DENSITY AS DETERMINED BY ASTM D698

COMPACTION TEST. MAINTAINING MOISTURE CONTENT BETWEEN -1 AND +3 PERCENTAGE

POINTS UNTIL COVERED. EXCESS FILL AT BUILDING PERIMETER SHALL BE CUT AND

<u>UF-8</u> PERFORM ALL EARTH WORK DESCRIBED ABOVE BEFORE TRENCHING FOR GRADE BEAMS OR MECHANICAL LINES.

GRADED TO COMPLY WITH FINISHED GRADE REQUIREMENTS.

REQUIRED.

THE STRUCTURAL SYSTEM FOR THIS PROJECT SHALL NOT BE CONSTRUCTED BY USING THE STRUCTURAL DRAWINGS ALONE. THESE DRAWINGS WERE DEVELOPED FROM DATA DERIVED PRIMARILY FROM THE ARCHITECTURAL DRAWINGS AND SECONDARILY FROM MEP. CIVIL AND OTHER DISCIPLINES' DOCUMENTS. IT IS INTENDED THAT CONSTRUCTION PROCEED BY UTILIZING ALL OF THE INFORMATION CONTAINED IN THE ENTIRE SET OF CONSTRUCTION DOCUMENTS TAKEN AS A WHOLE; FAILURE TO DO SO WILL RESULT IN ERRORS WHICH SHALL BE CORRECTED AT THE CONTRACTOR'S EXPENSE.

BRACKENRIDGE PARK

SAN ANTONIO, TX

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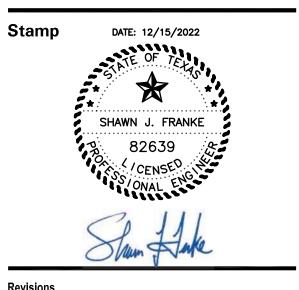
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Revisions

Date 11 JANUARY 2023 Phase 95% CONSTRUCTION DOCUMENTS Job Number					
CNOS701					
Scale	North				
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	NOTES				
Drawing Number					
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03 LA PROJECT LA FILE NO.:





EXISTING WALL STRUCTURAL STABILIZATION & REHABILITATION PLAN SCALE: 1" = 20'-0"

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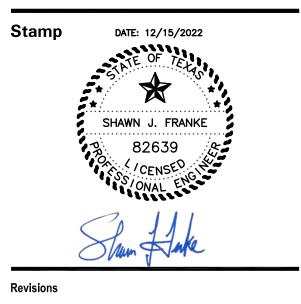
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Date

Phase

CNOS701

11 JANUARY 2023

Job Number


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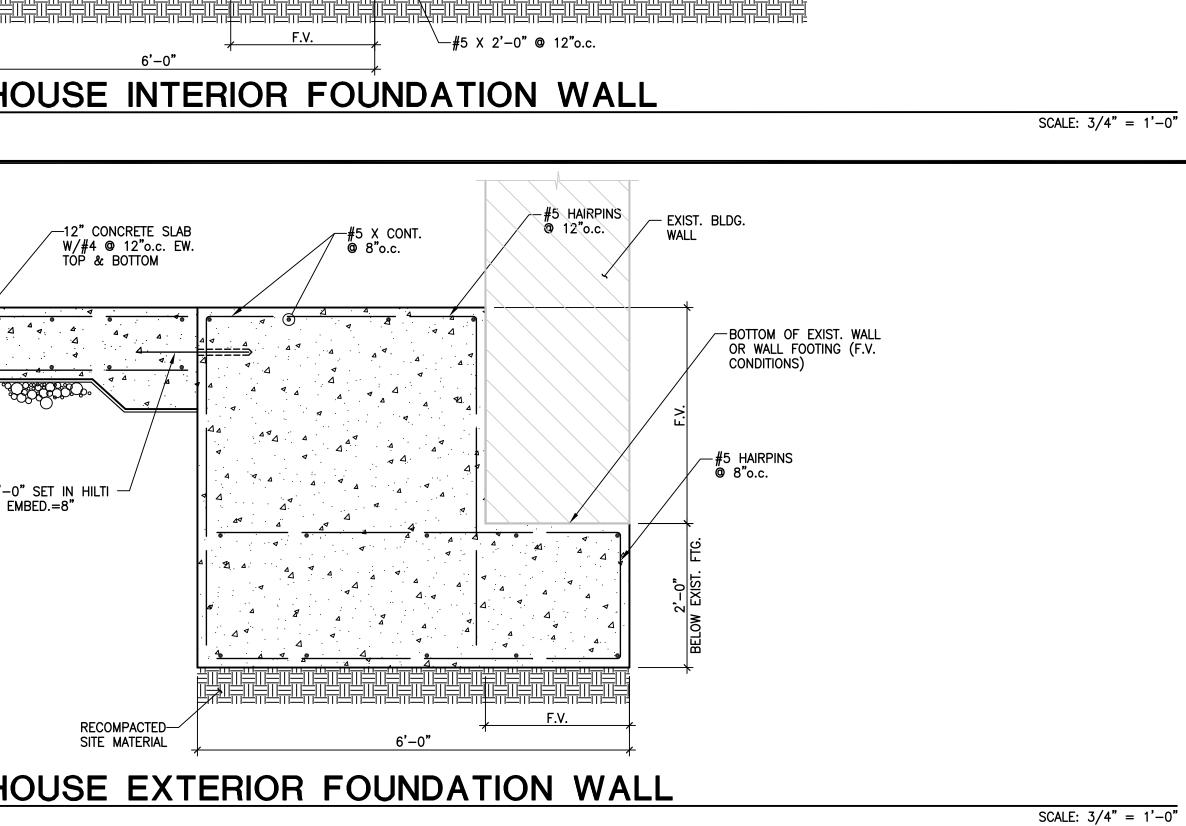
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95% CONSTRUCTION DOCUMENTS

EXISTING WALL STRUCTURE STABILIZATION & REHABILITATION PLAN

Drawing Number




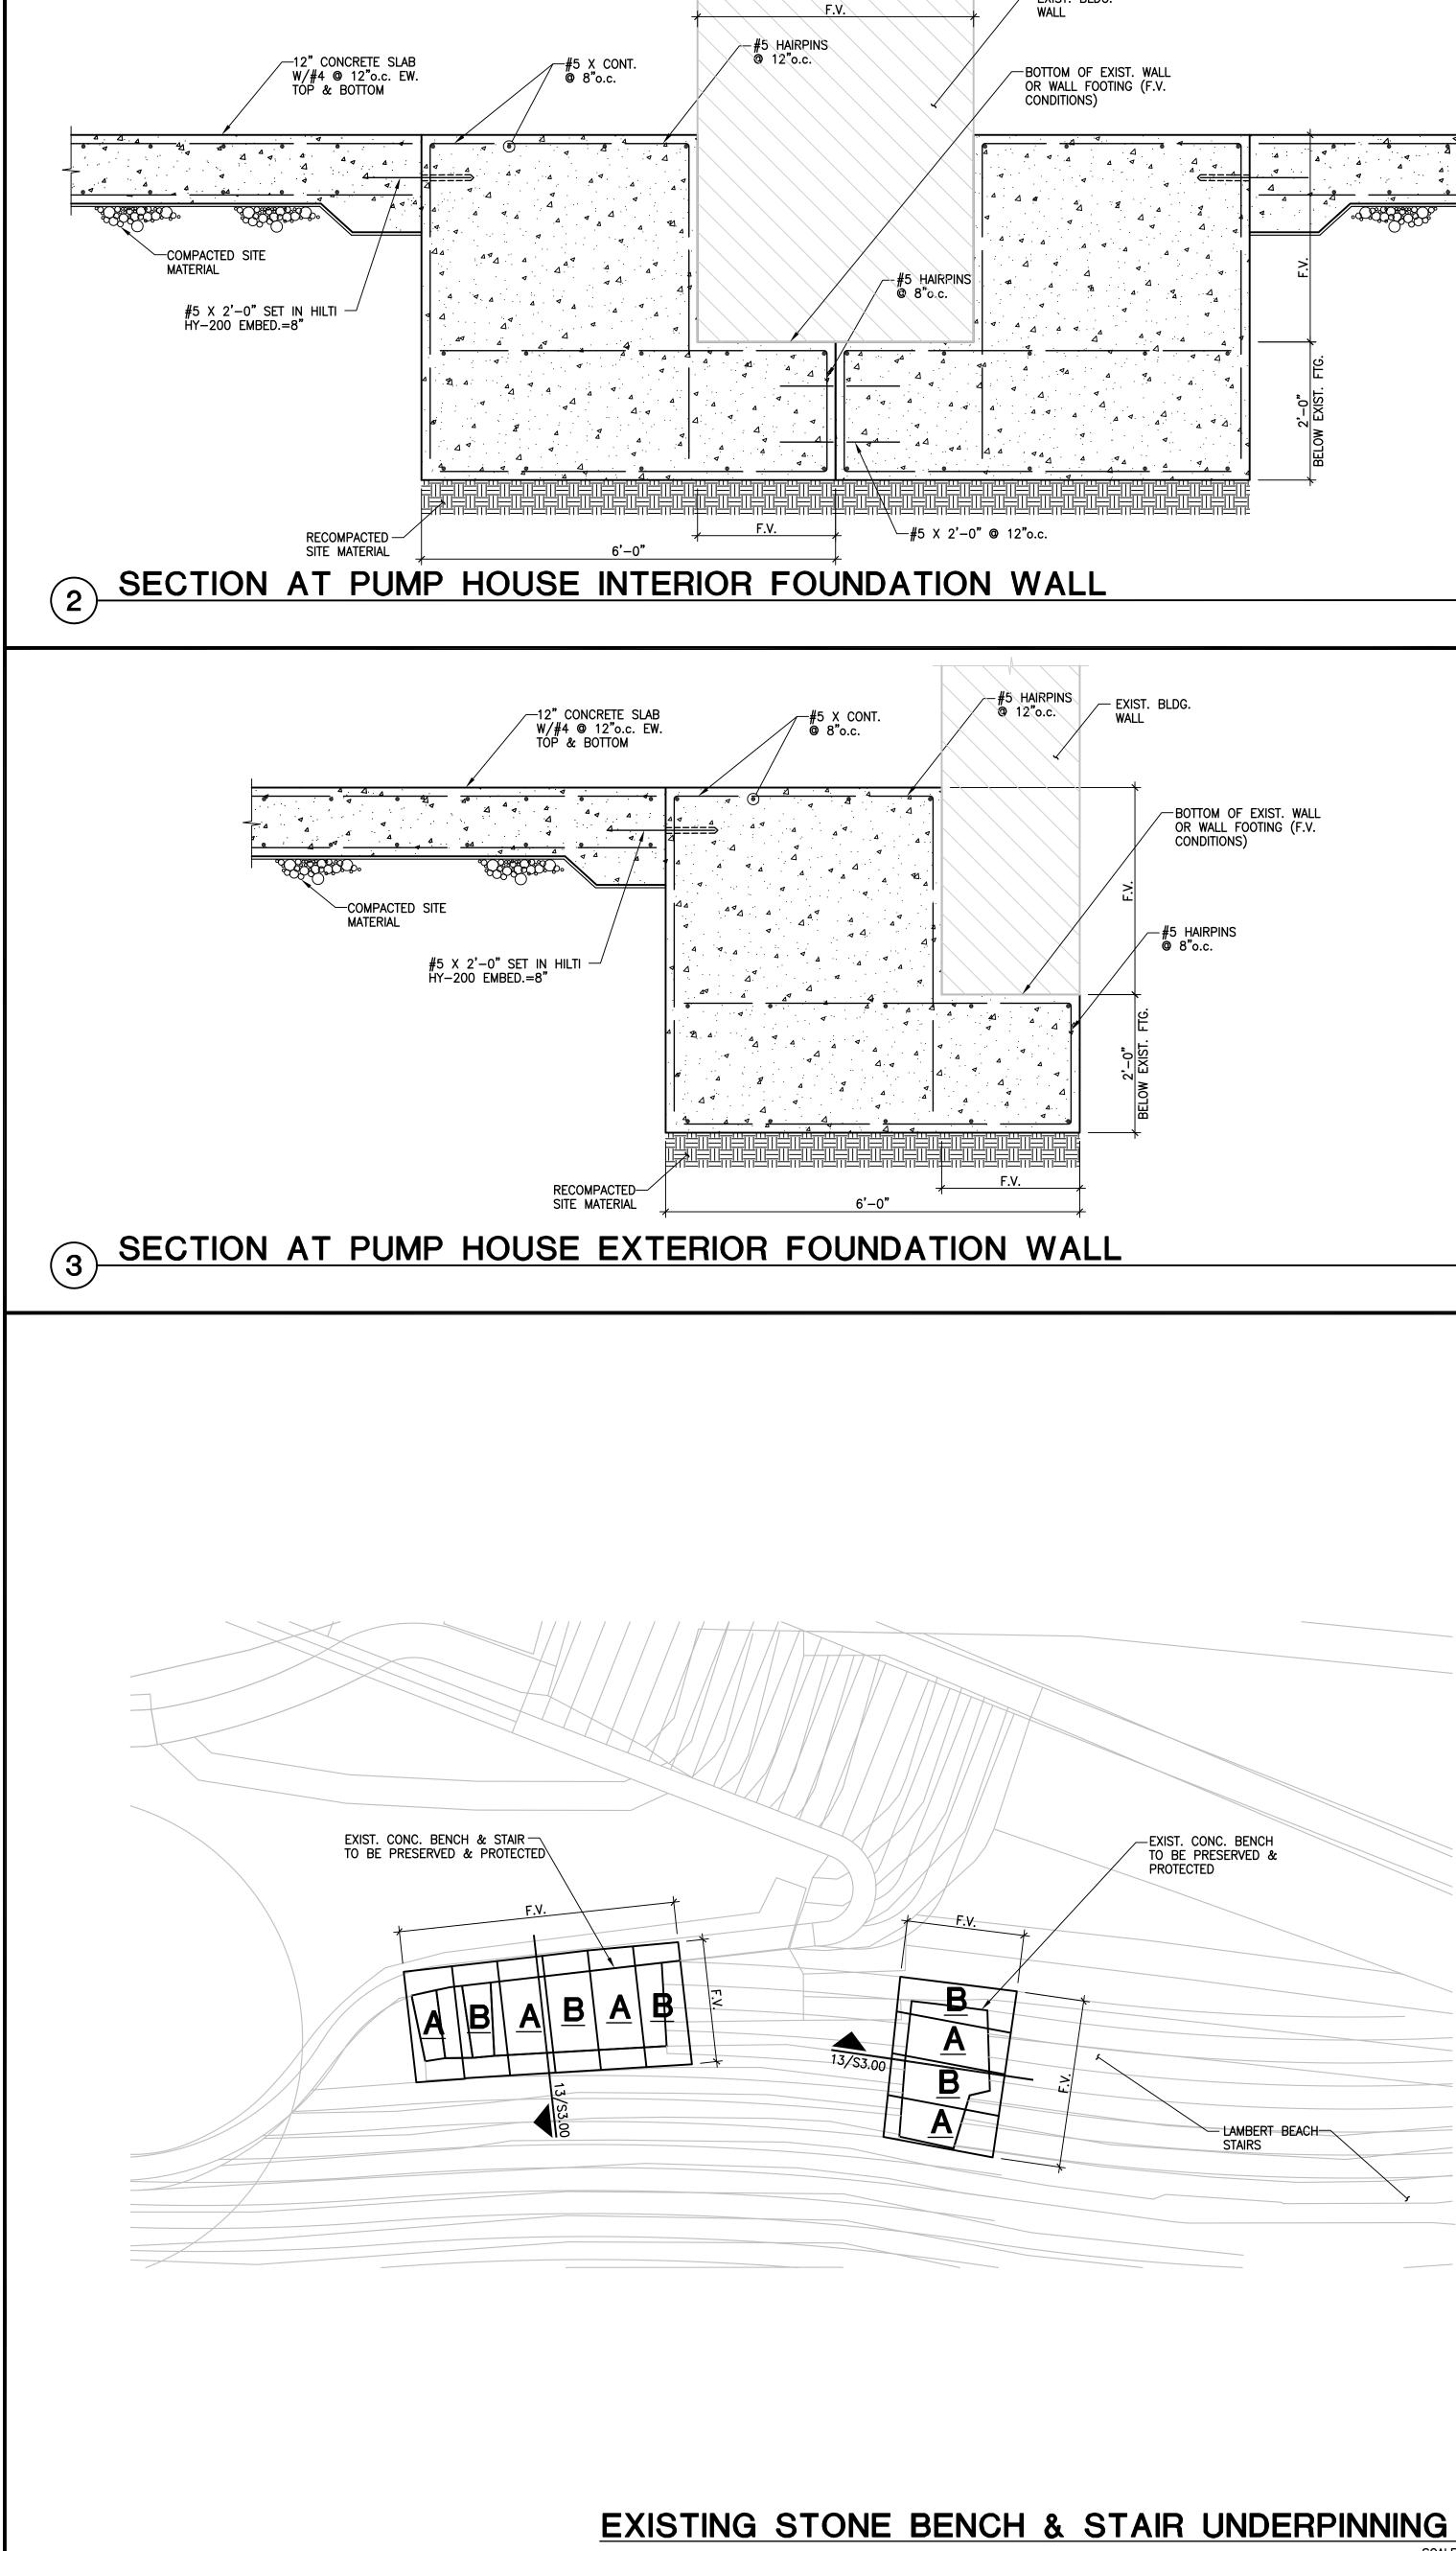

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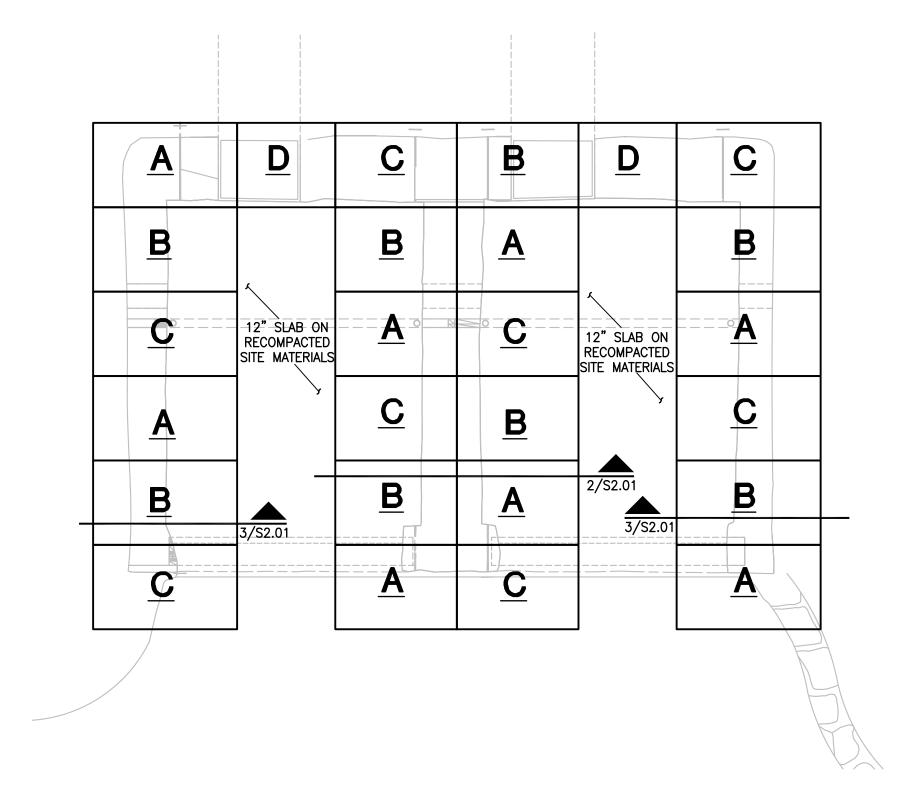
EXISTING STONE BENCH & STAIR UNDERPINNING PLAN SCALE: 1/4" = 1'-0"



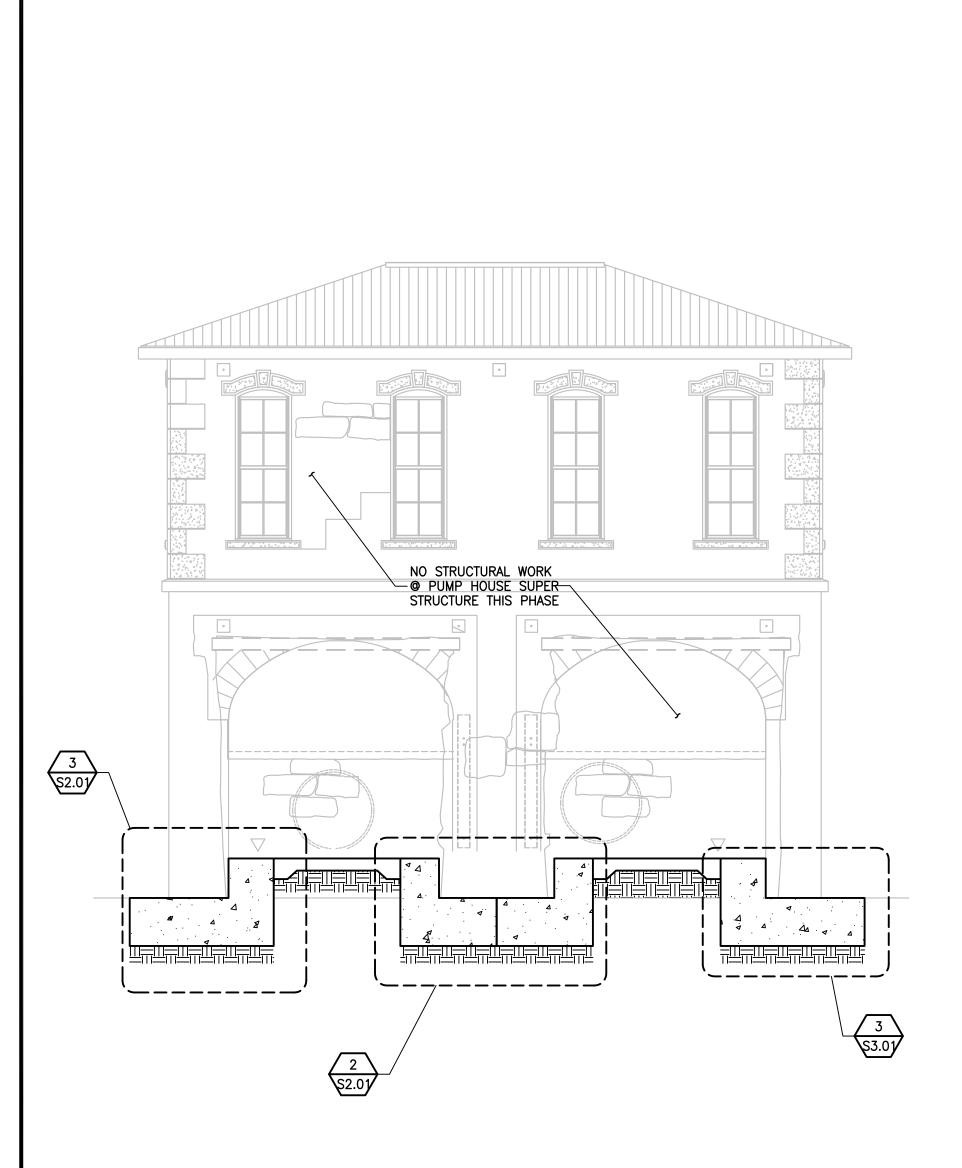

* CONTRACTOR RESPONSIBLE FOR TEMPORARY SHORING OF EXISTING BUILDING DURING SEQUENTIAL EXCAVATION

SCALE: 1/4" = 1'-0"



PUMP HOUSE FOUNDATION UNDERPINNING PLAN

ENGINEER REPLACE EXISTING SLAB AFTER EXCAVATION AS SHOWN IN DETAILS 2 & 3/S2.01

Q333300

2. NO TWO ADJACENT AREAS MAY BE EXCAVATED @ THE SAME TIME 3. CONTRACTOR RESPONSIBLE FOR SHORING OF EXISTING STRUCTURE BY EXPERIENCED SHORING

PLAN NOTES: 1. EXCAVATION OF FOUNDATION TO BE ALLOWED IN ALPHABETICAL SEQUENCE.

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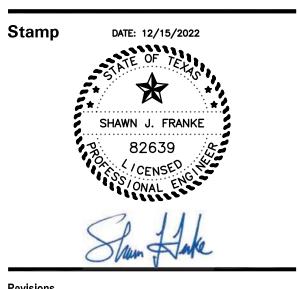
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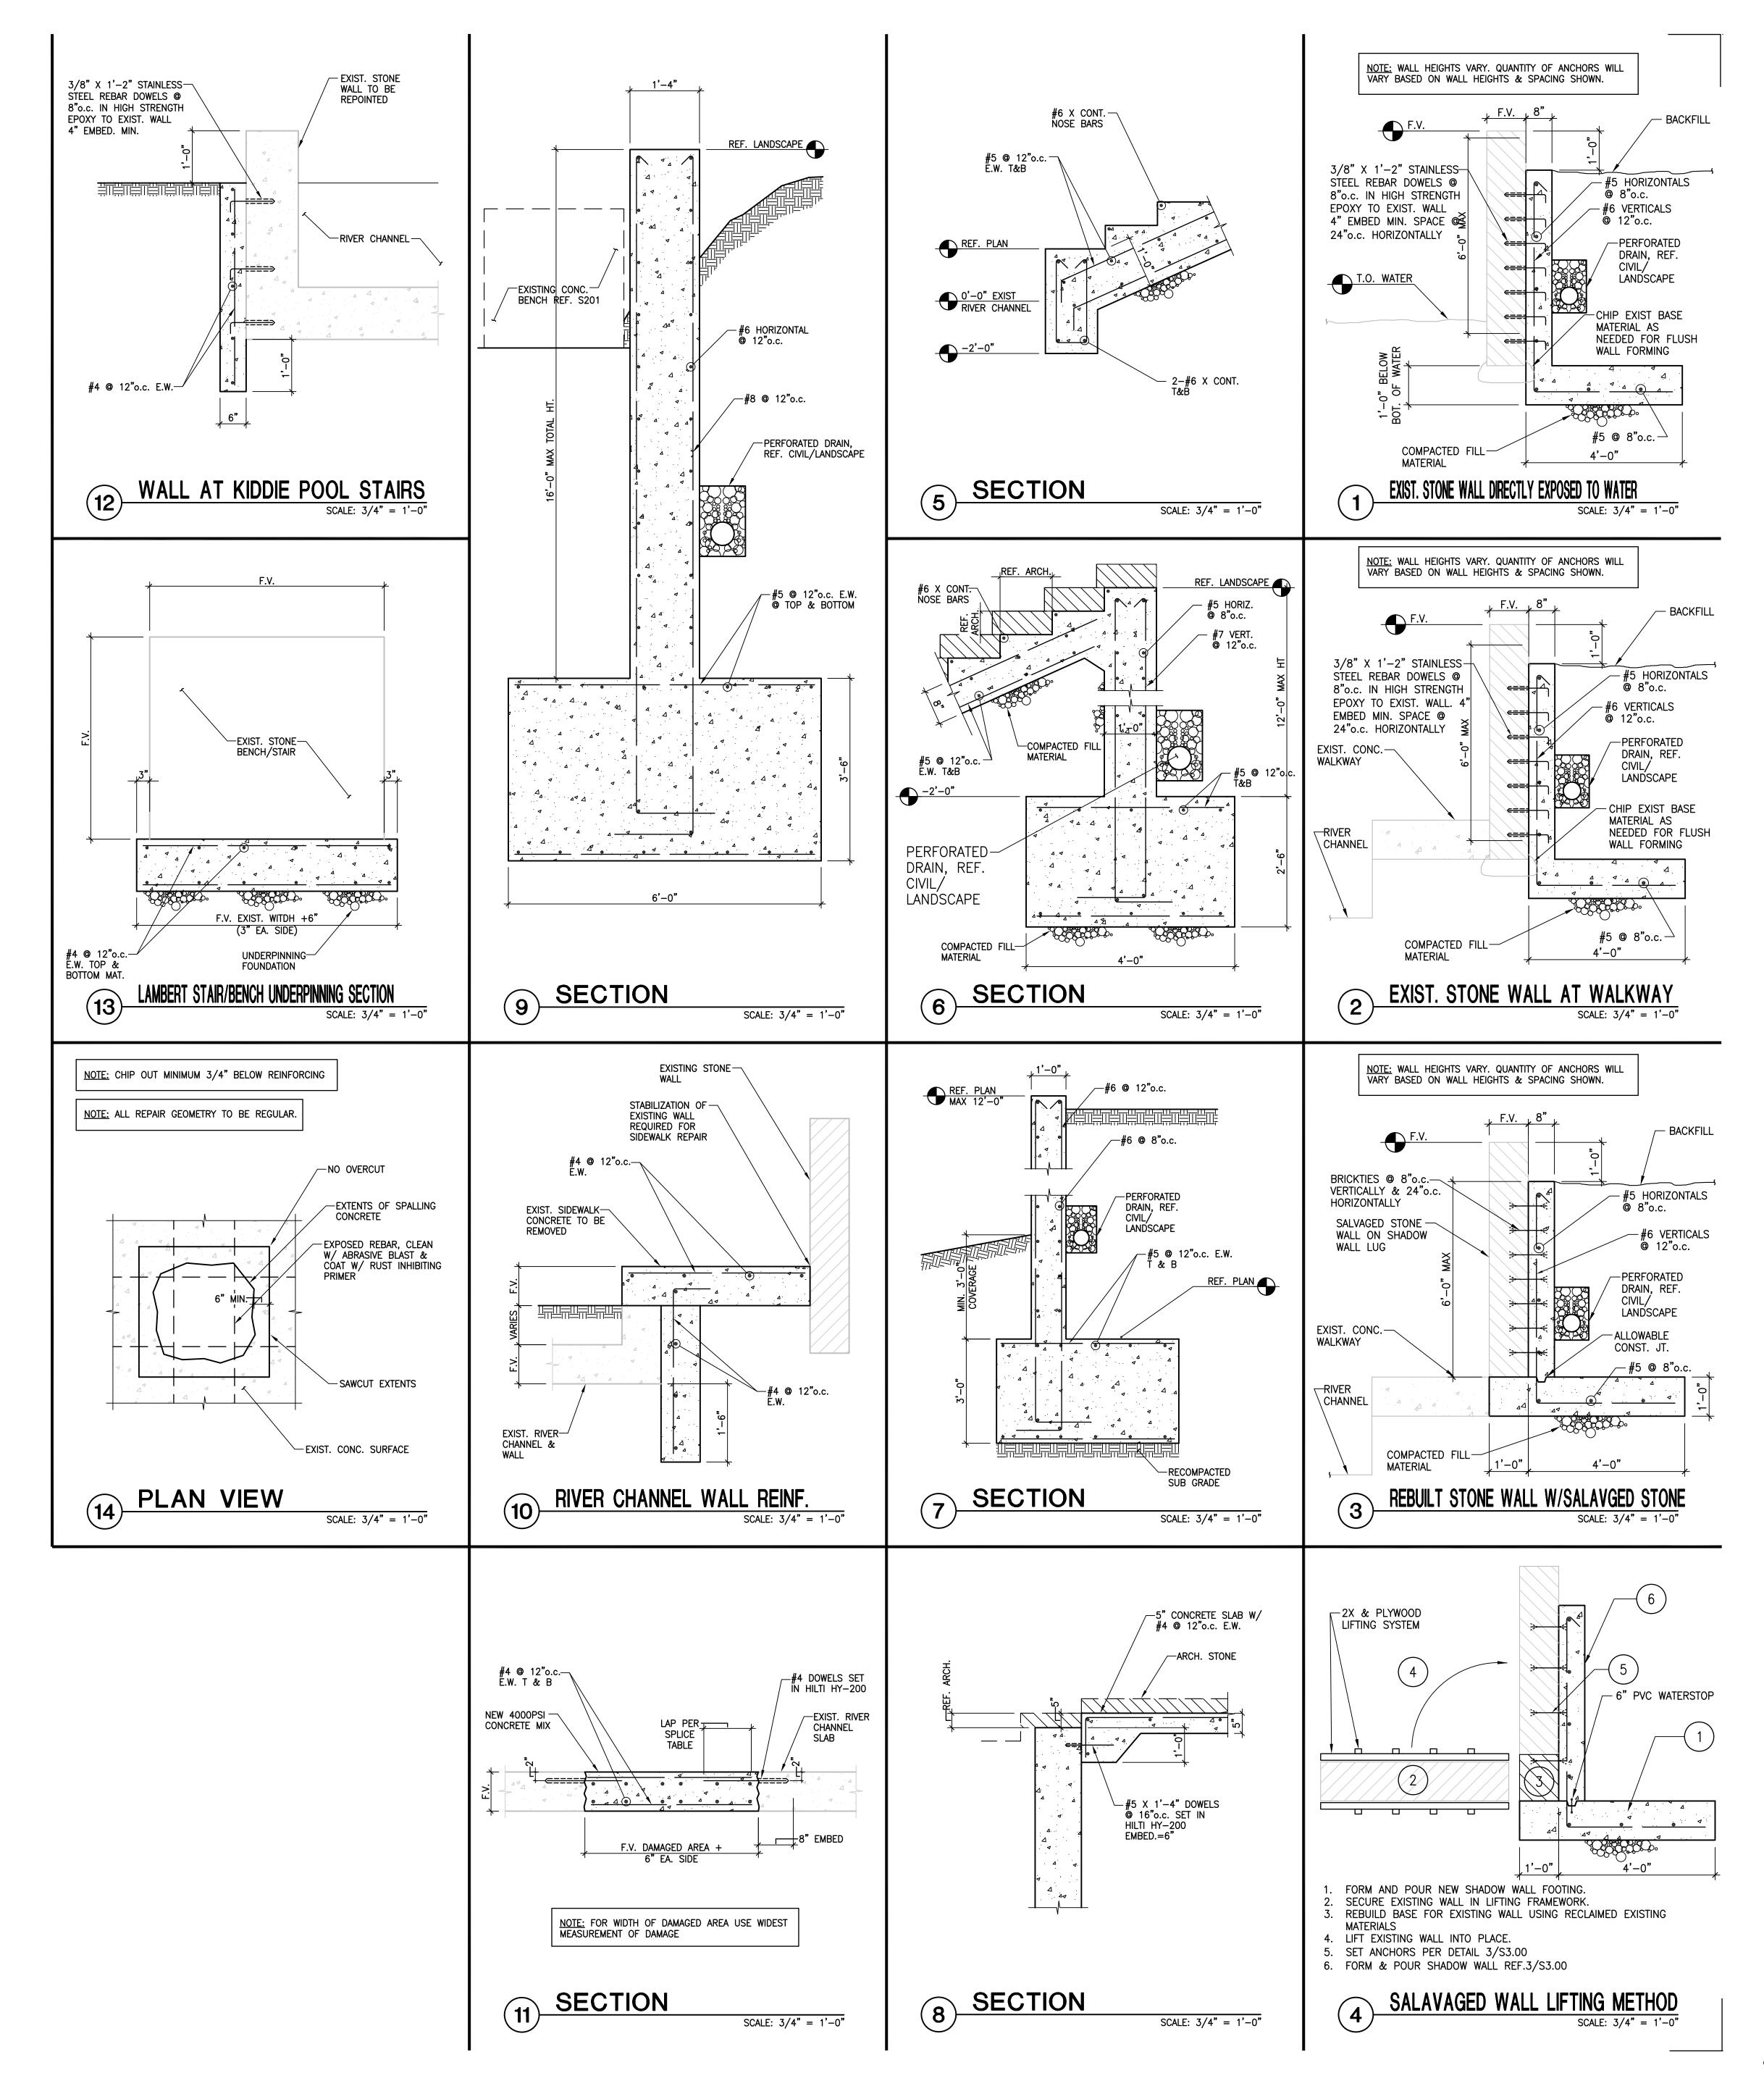
Date

11 JANUARY 2023

Phase 95% CONSTRUCTION DOCUMENTS Job Number CNOS701 Drawing Title FOUNDATION UNDERPINNING PLAN AND SECTIONS

Drawing Number

LA PROJECT NO.: 03-257-00 LA FILE NO.: BRWBRS3-00



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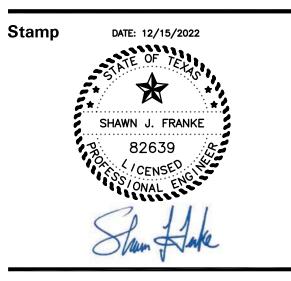
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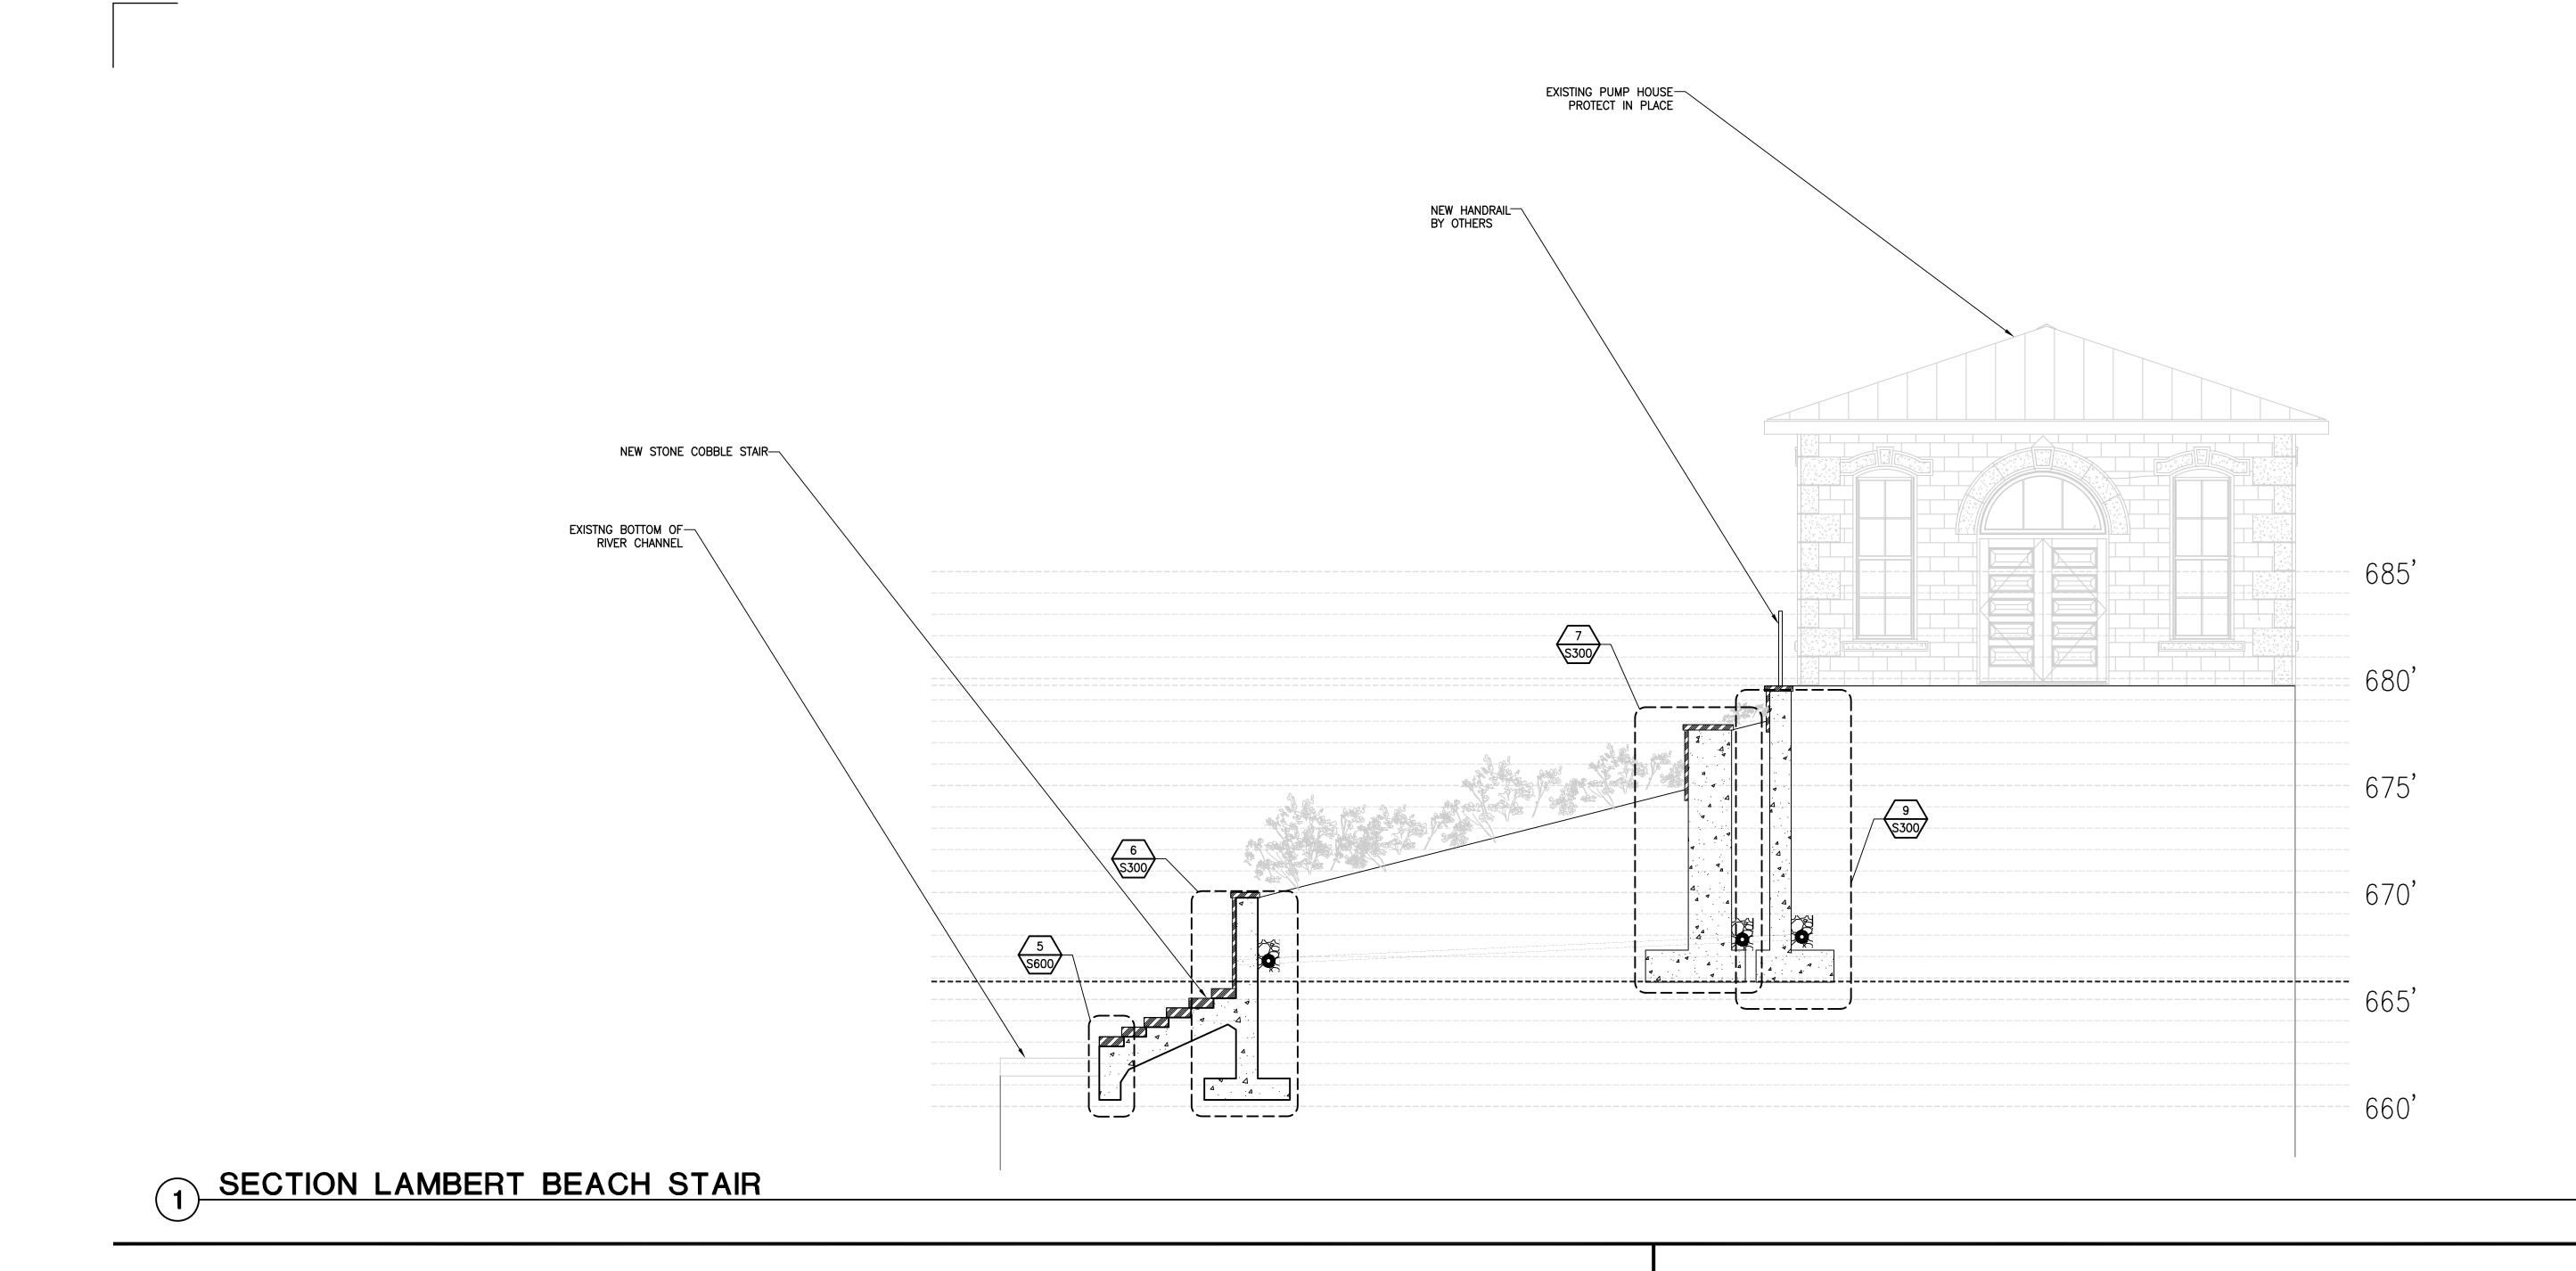
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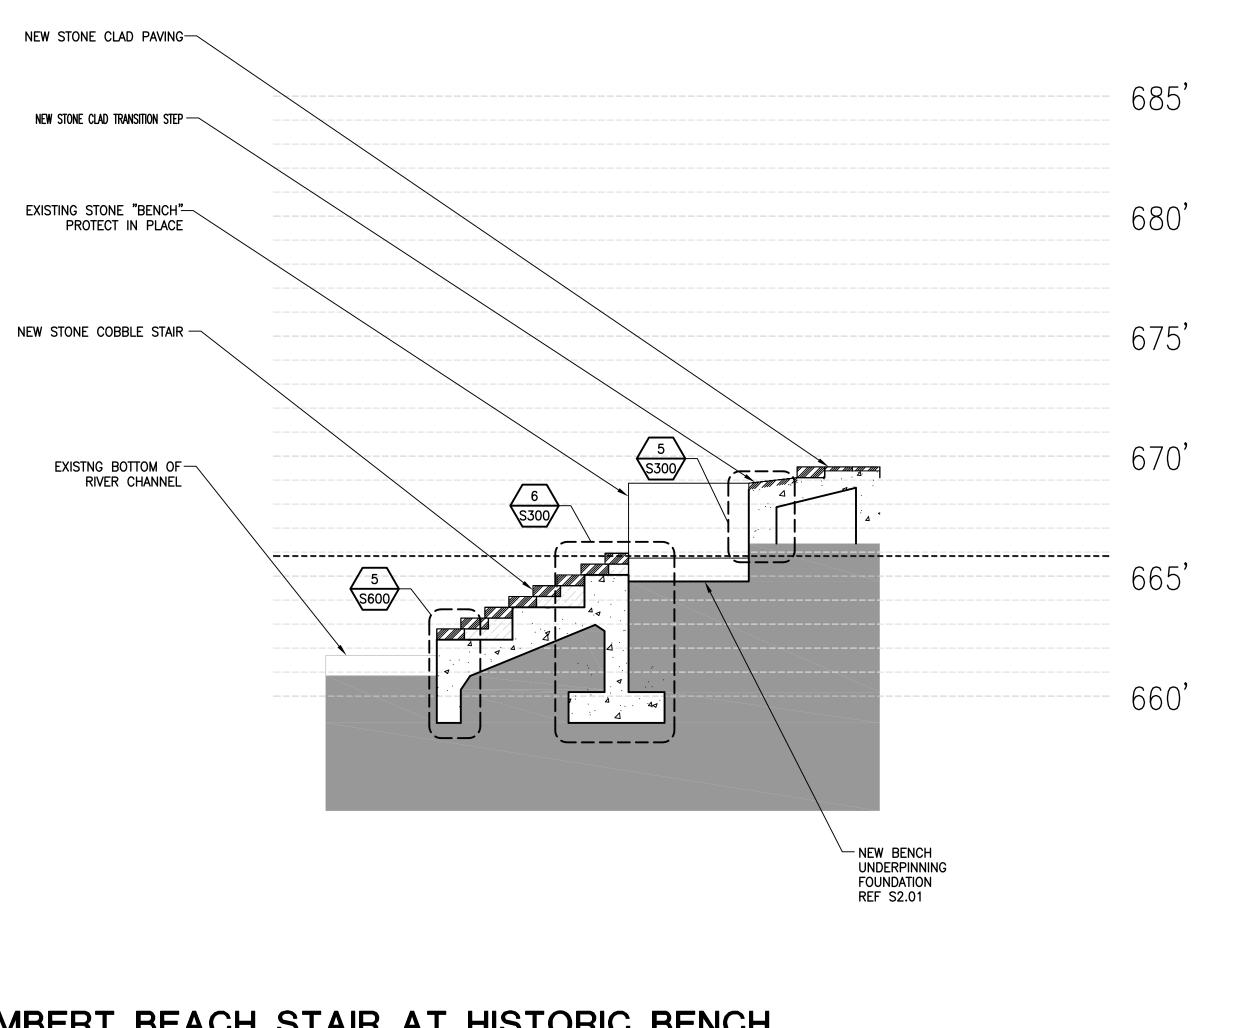
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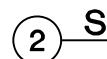
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-257 53-01 LA PROJECT LA FILE NO.:


3 SECTION LAMBERT BEACH STAIR AT HISTORIC BENCH




SCALE: 1/4" = 1'-0"



2 SECTION LAMBERT BEACH STAIR AT HISTORIC STONE STAIR

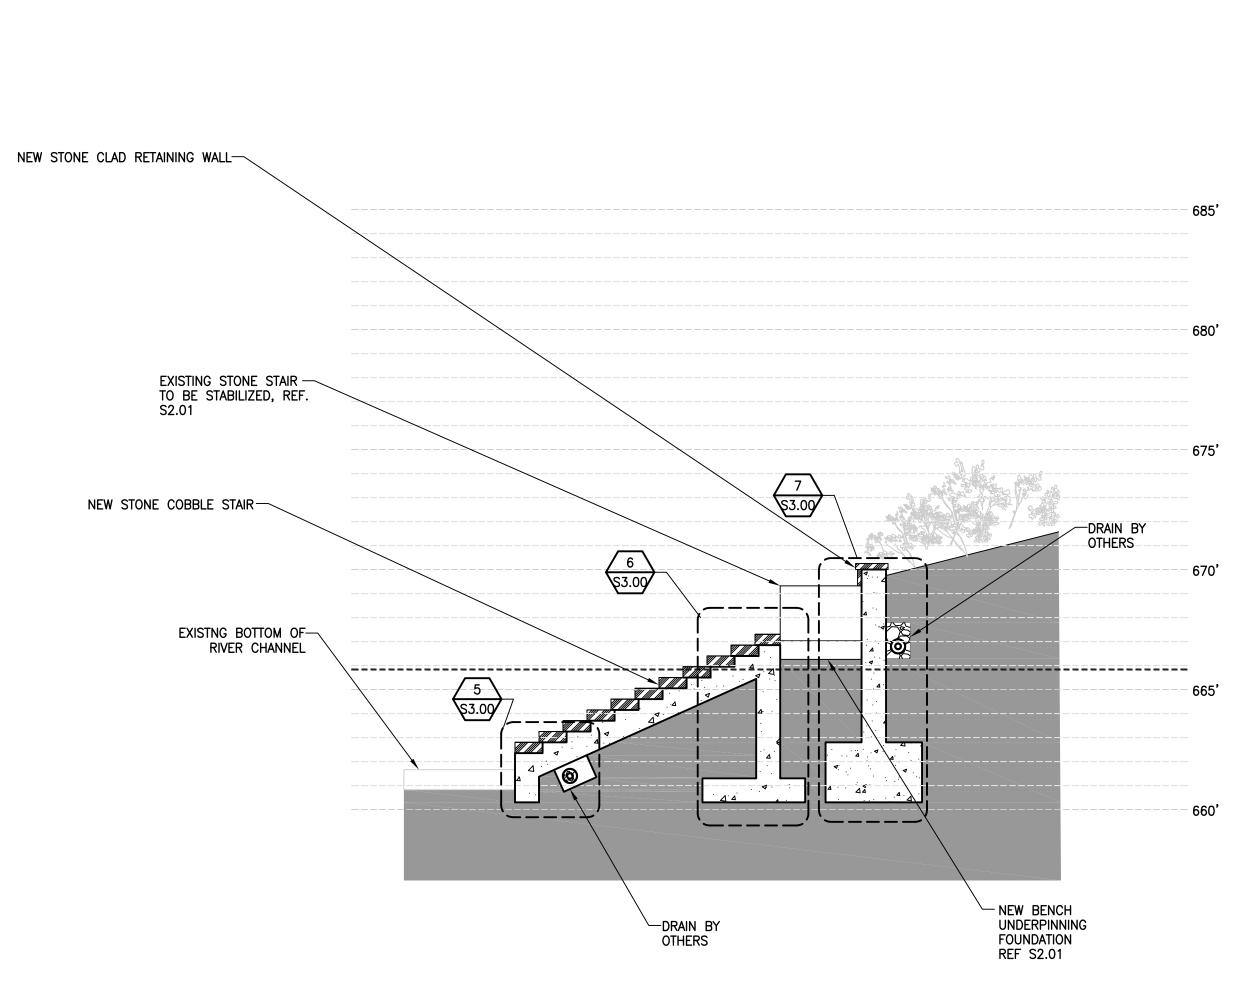

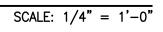

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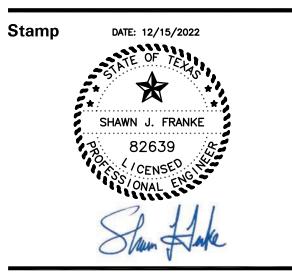
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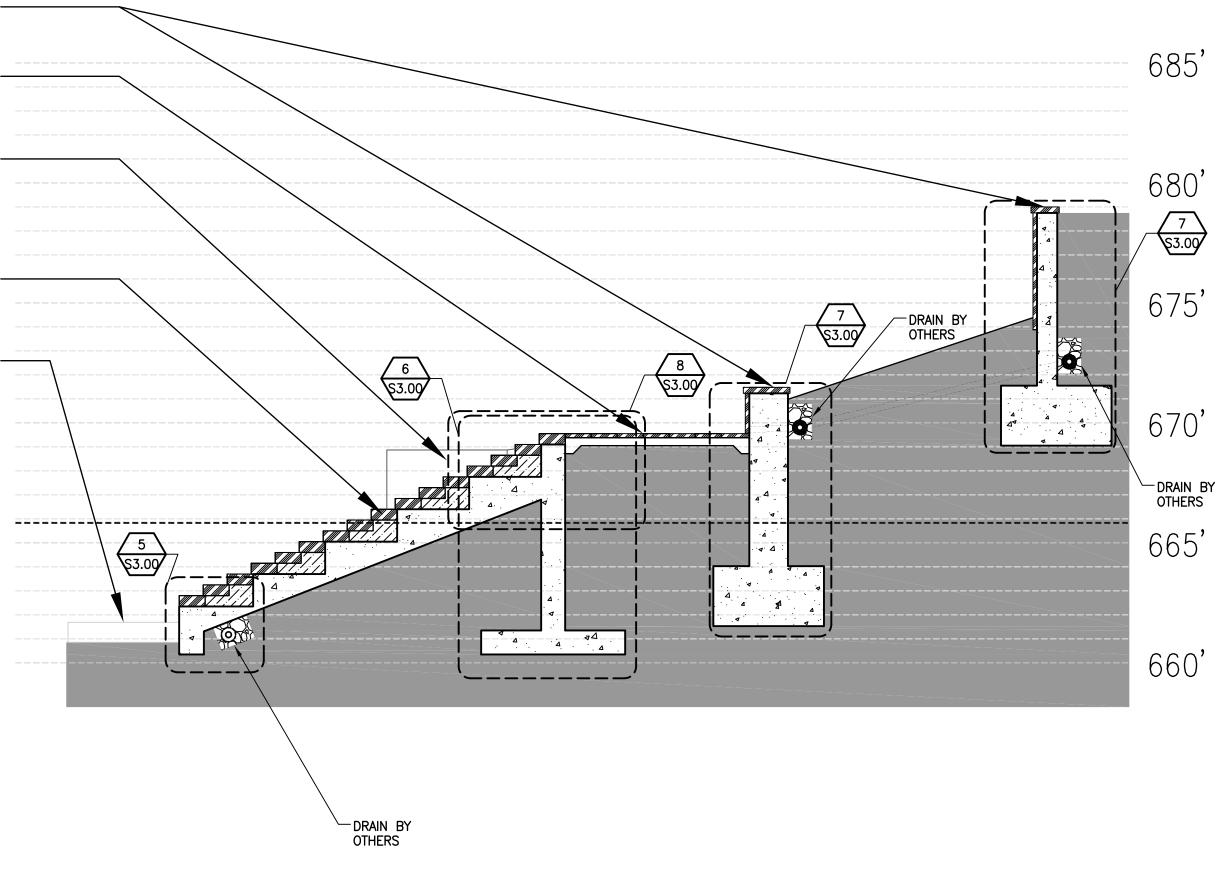
-257 S3-02 03 NO. BR LA PROJECT LA FILE NO.: NEW STONE CLAD RETAINING WALL

NEW STONE CLAD PAVING

EXISTING STONE "BENCH" PROTECT IN PLACE

NEW STONE COBBLE STAIR

EXISTNG BOTTOM OF RIVER CHANNEL



1 SECTION LAMBERT BEACH LARGE STAIR

SCALE: 1/4" = 1'-0"

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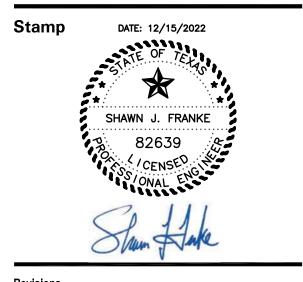
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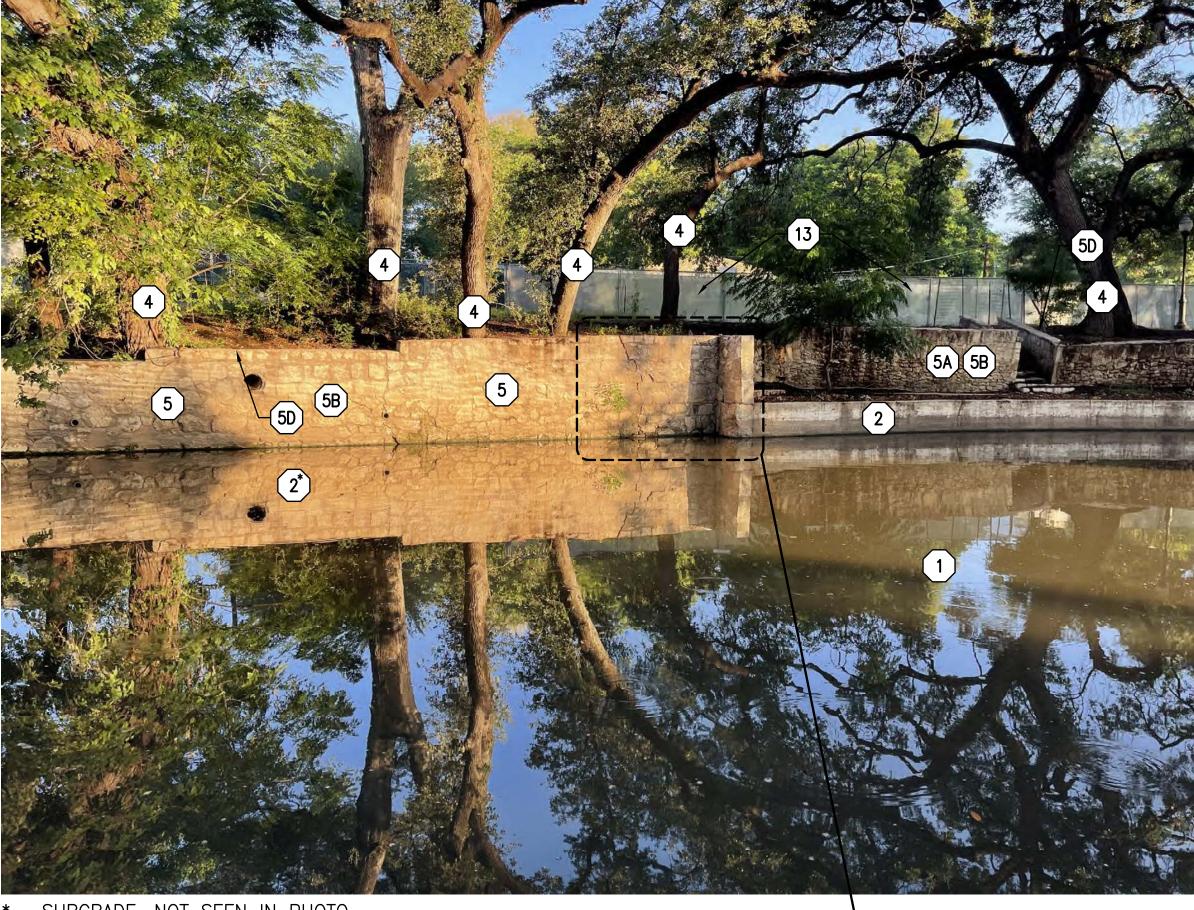
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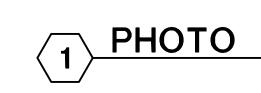
Revisions


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* SUBGRADE, NOT SEEN IN PHOTO





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LA PROJECT NO.: 03-257-00 LA FILE NO.: BRWBRS4-00

(3) PHOTO

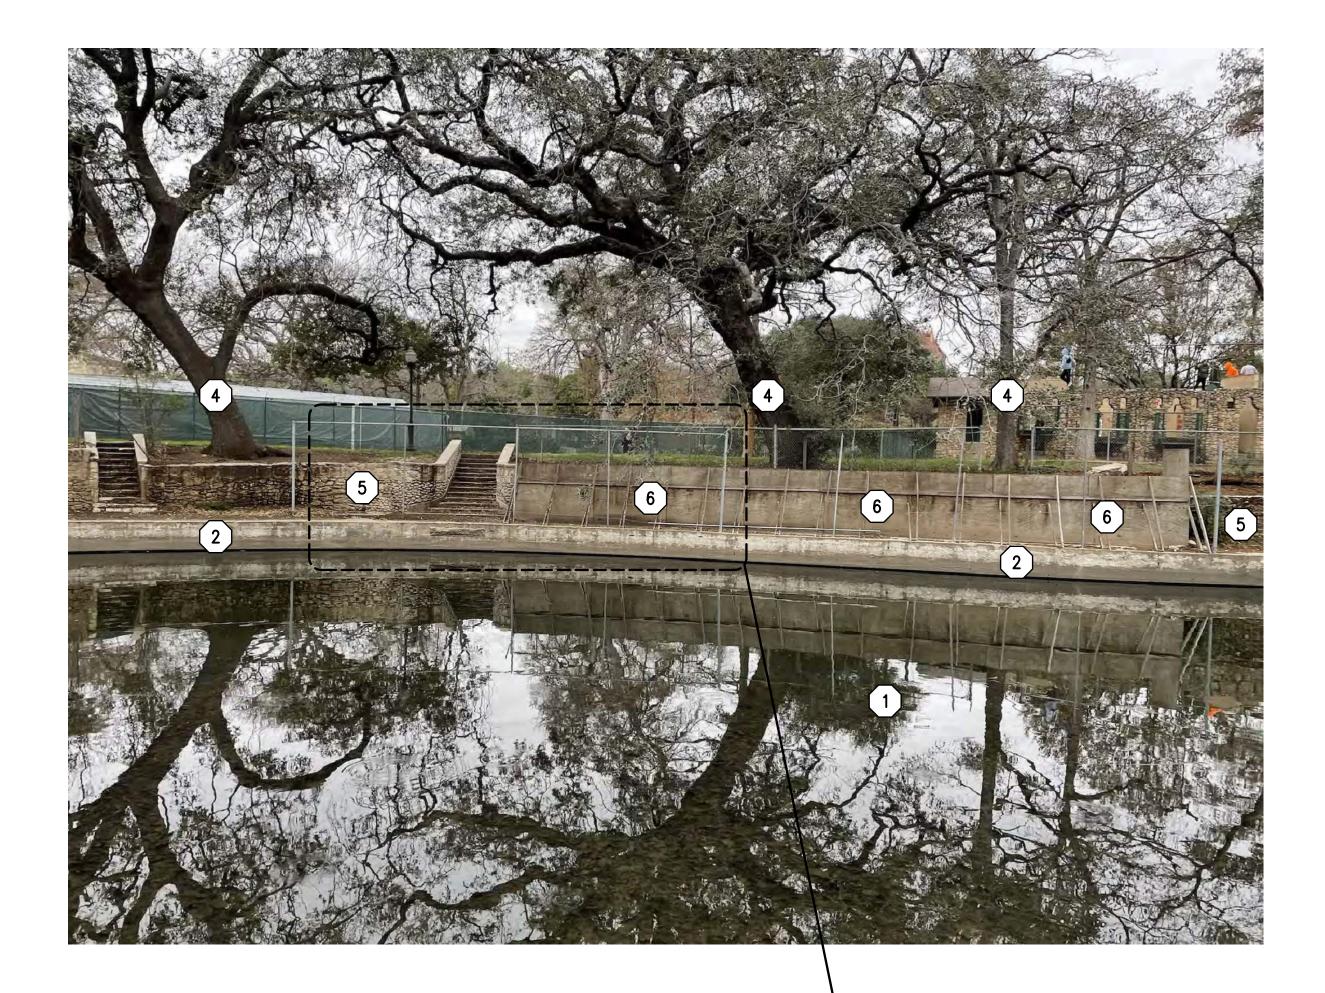

TYPICAL N.T.S.

S4.04

2 PHOTO



4 \$4.04

TYPICAL N.T.S. TYPICAL N.T.S. KEYNOTES
 EXISTING CHANNEL BOTTOM TO REMAIN. EXISTING CHANNEL BOTTOM TO BE REPAIRED AS NECESSARY DURING CONSTRUCTION BASED ON SITE CONDITIONS EXPOSED DURING DEWATERING. ALL ORGANIC AND DELETERIOUS MATERIAL TO BE REMOVED FROM THE CHANNEL AFTER DEWATERING TO ALLOW FOR FULL ASSESSMENT OF THE EXISTING CONCRETE CHANNEL. PRECAUTIONS TO BE TAKEN DURING CONSTRUCTION TO PREVENT FURTHER DAMAGE TO THE EXISTING CHANNEL. CONTRACTOR RESPONSIBLE FOR ALL DAMAGE BEYOND EXISTING DAMAGE, CAUSED BY CONSTRUCTION ACCESS.
 EXISTING CONCRETE CHANNEL WALL TO REMAIN.

 3. EXISTING CONCRETE WALKWAY SLAB TO BE REMOVED AND REPLACED WITH NEW CONCRETE SLAB. EXISTING CHANNEL WALL TO BE BACKED WITH SHADOW WALL BELOW NEW WALKWAY SLAB PER STRUCTURAL DETAILS.
 4. TREE/VEGETATION TO BE REMOVED. ALL TREE/VEGETATION REMOVAL TO BE COMPLETED ACCORDING TO LANDSCAPING/TREE REMOVAL AND MITIGATION DRAWINGS.
 5. EXISTING STONE RETAINING WALL TO REMAIN AND BE ANCHORED TO AND SUPPORTED BY A NEW CAST-IN-PLACE CONCRETE "SHADOW" WALL BEHIND THE EXISTING STONE WALL. ALL STONE WALLS TO BE ANCHORED TO NEW "SHADOW WALL BY MEANS DEPECTIED IN DETAILS

- WITHIN THIS SET OF DRAWINGS.
 A. REALIGN EXISTING RETAINING WALL TO REMAIN AND BE REALIGNED TO A MORE VERTICAL POSITION. FIELD VERIFY VERITCAL ALIGNMENT. WALLS SECTIONS FIELD VERIFIED TO BE LEANING OUTWARD TOWARDS THE CHANNEL/RIVER SHALL BE ATTEMPTED TO BE REALIGNED TO A MORE VERTICAL POSITION. ALL ATTEMPTS TO REALIGN WALLS VERTICALLY SHALL BE LIMITED TO NON-DESTRUCTIVE METHODS.
 B. REPOINTING - CRACKS IN EXISTING STONE WALLS SHALL BE REPOINTED WITH MASONRY
- MORTAR AS SPECIFIED IN SPECIFICATIONS SECTION 040342 HISTORIC STONE MASONRY REPAIR AND REPOINTING. C. NEWLY BONDED STONE PIECES/SECTIONS - EXISTING STONE PIECES THAT ARE BROKEN AND/OR SEPARATED FROM THE EXISTING STONE WALL OR SECTIONS OF WALL THAT ARE BROKEN SHALL BE REBONDED WITH ALIGNED STONE WALL SECTIONS WITH MASONRY
- MORTAR AS SPECIFIED IN SPECIFICATIONS SECTION 040342 HISTORIC STONE MASONRY REPAIR AND REPOINTING. D. CEMENTATIOUS CAP - REPAIRS TO ANY EXISTING CEMENTATIOUS CAP ON EXISTING STONE WALLS SHALL BE REPAIRED OR RECONSTRUCTED WITH MASONRY MORTAR AS SPECIFIED IN SPECIFICATIONS SECTION 040342 HISTORIC STONE MASONRY REPAIR AND REPOINTING.
- E. TOP OF EXISTING WALL DO NOT ADD TO THE HEIGHT OF THE EXISTING WALL. REALIGNMENT OF THE WALL INTO A MORE VERTICAL POSITION IS NOT CONSIDERED ALTERING THE HEIGHT OF THE EXISTING WALL.
 (6.) NEW STONE WALL TO BE CONSTRUCTED UTILIZING RECLAIMED/SALVAGED STONE AND NEW STONE USING HISTORICAL CONSTRUCTION ALLOWABLE METHODS OUTLINED WITHIN
- SPECIFICATIONS. NEW STONE WALL TO BE BACKED AND ANCHORED TO NEW CAST-IN-PLACE CONCRETE "SHADOW" WALL SHOWN IN DETAILS WITHIN THIS STRUCTURAL SET. OWNER WILL PROVIDE MAJORITY OF SALVAGED STONE. CONTRACTOR MAY HAVE TO SUPPLEMENT WITH SAME TO FULLY CONSTRUCT. 7. FAILED EXISTING CONCRETE CHANNEL WALL TO BE REMOVED AND REPLACED WITH NEW CONCRETE PER DETAILS WITHIN THIS STRUCTURAL SET. MULTI-PLANAR FAILURE OF
- CONCRETE CAUSED BY EXPOSURE TO SCOURING FORCES OF RIVER. (8) EXISTING FALLEN STONE WALL SECTION TO BE RECLAIMED AND LIFTED BACK INTO ALIGNMENT WITH EXISTING STONE WALL. NEW CAST-IN-PLACE CONCRETE WALL TO BE PLACED BEHIND EXISTING STONE WALL FOR SUPPORT AND ANCHORAGE. (9) EXISTING PUMP HOUSE FOUNDATION TO BE REMOVED AND REPLACED WITH CONCRETE
- UNDERPINNING AS DETAILED ON \$2.01. EXISTING STRUCTURE TO BE SHORED PRIOR TO COMMENCMENT OF UNDERPINNING.
 EXISTING PUMP HOUSE. NO STRUCTURAL WORK ABOVE FOUNDATION TO BE COMPLETED IN THIS PHASE. TEMPORARY SHORING DURING FOUNDATION UNDERPINNING TO BE IN PLACE
- PRIOR TO COMMENCMENT OF CONSTRUCTION. (1) EXISTING CONCRETE AND OR MASONRY STAIRS NOT INDICATED TO BE PORTIONS OF HISTORICAL CONSTRUCTION TO BE REMOVED IN ENTIRETY AND REPLACED WITH NEW CAST-IN-PLACE CONCRETE STAIRS. REFER TO LANDSCAPE DRAWINGS FOR EXACT LOCATIONS OF PORTIONS OF STAIRS TO REMAIN. (12) EXISTING CONCRETE RAMPS TO REMAIN IN PLACE.

(13) NOT IN SCOPE

EXISTING STONE WALL TO BE DEMOLISHED AT JOINT OF ORIGINAL WALL & NEWER WALL & BE REBUILT WITH CONCRETE SHADOW WALL

* ITEMS LABELED AS NOTE 5 OR 5 SUBNOTE MAY HAVE MORE THAN ONE APPLICABLE SUBNOTE BASED ON CONDITIONS ENCOUNTERED AT TIME OF CONSTRUCTION

NOTES AND REFERENCES: ACCIDENTAL DAMAGE - CONTACT THE OWNER AND DESIGN TEAM IN THE EVENT OF DAMAGE TO THE EXISTING WALLS OR ADJACENT SITE FEATURES THAT RESULT IN WALLS SECTIONS

 DAMAGE TO WALL AND ADJACENT FEATURES AND COORDINATE WITH REQUIRED PARTIES PRIOF

 TO ATTEMPTING REPAIRS.

 FOR ALL WORK RELATED TO THE REMOVAL, DISMANTLING, CLEANING, REPAIR AND TREATMENT

 OF EXISTING STRUCTURES REFER TO THE FOLLOWING SPECIFICATIONS FOR ALL ALLOWABLE

 METHODS AND MATERIALS:

 GENERAL HISTORIC TREATMENT PROCEDURES: SPECIFICATIONS SECTION 013591 HISTORIC

BECOMING DISLODGED OR FALLING INTO THE CHANNEL. ALLOW FOR DESIGN TEAM TO ASSESS

TREATMENT PROCEDURES
<u>REMOVAL AND DISMANTLING OF STONE:</u> SPECIFICATIONS SECTION 024296 HISTORIC REMOVAL

AND DISMANTLING

CLEANING OF STONE: SPECIFICATIONS SECTION 040310 HISTORIC STONE MASONRY CLEANING

<u>REPAIR OF STONE:</u> SPECIFICATIONS SECTION 040342 HISTORIC STONE MASONRY REPAIR AND REPOINTING & 040515 PREPARING LIME MORTAR FOR HISTORIC MASONRY

TYPICAL N.T.S.

BRACKENRIDGE PARK

SAN ANTONIO, TX

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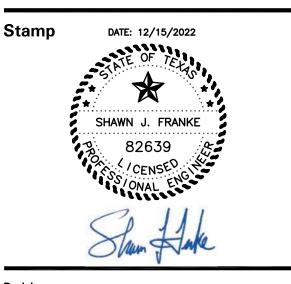
INTELLIGENT ENGINEERING SERVICE CIVIL ENGINEER 1045 CENTRAL PARKWAY NORTH, SUITE 200, SAN ANTONIO, TX 78232

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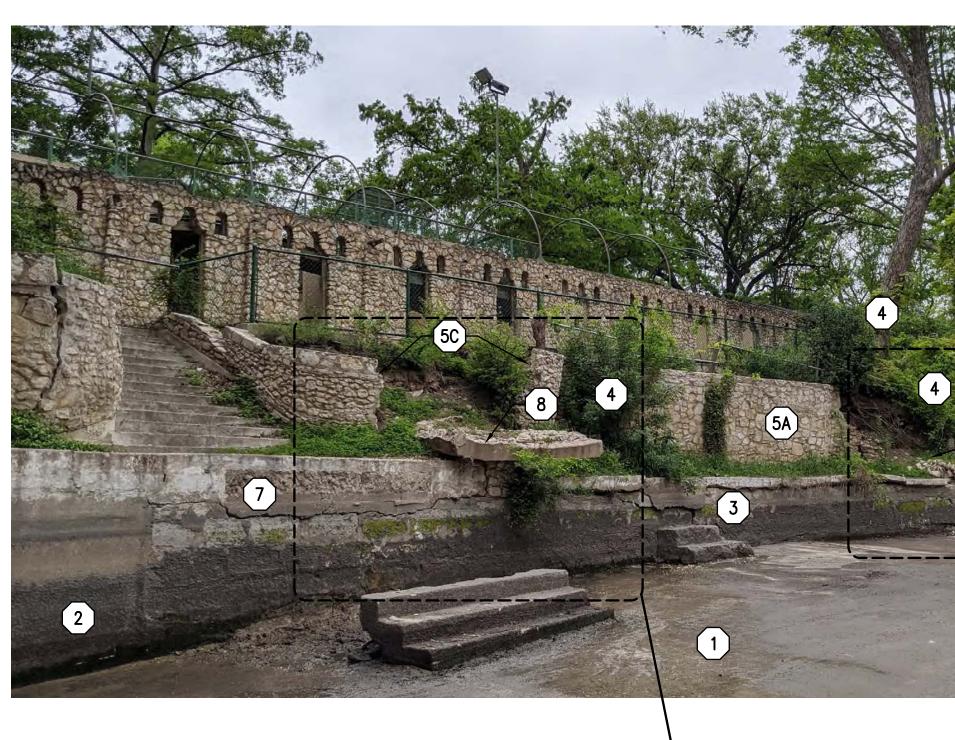
SAN ANTONIO TX, 78208



Revisions

Date 11 JANUARY 2023 Phase 95% CONSTRUCTION DOCUMENTS Job Number CNOS701 Scale North CONSTRUCTION DOCUMENTS Scale North CONSTRUCTION DOCUMENTS Drawing Title PHOTO SURVEY & KEYNOTES Drawing Number S4.000






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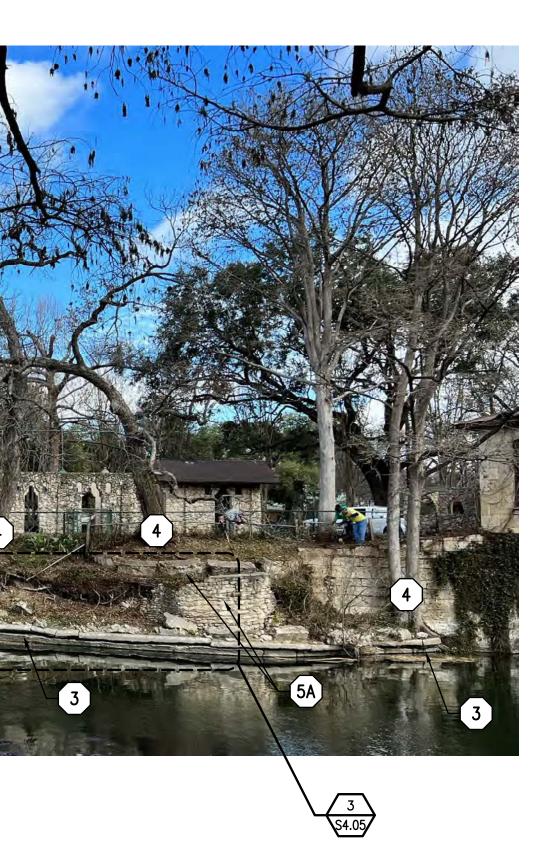




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TYPICAL 4 PHOTO

TYPICAL N.T.S.

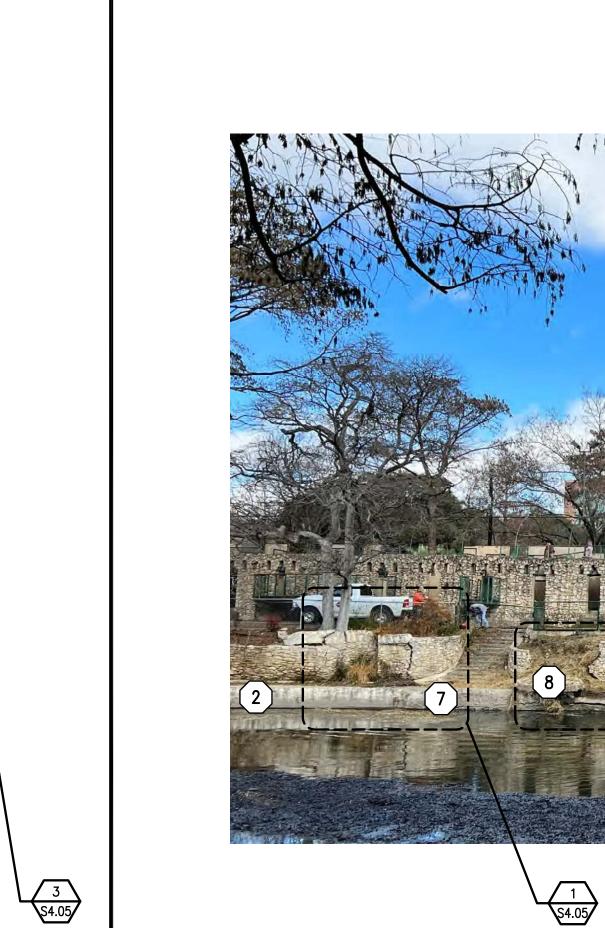

TYPICAL N.T.S.

- KEYNOTES
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 EXISTING CONCRETE CHANNEL WALL TO REMAIN.
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 5. EXISTING STONE RETAINING WALL TO REMAIN AND BE ANCHORED TO AND SUPPORTED BY A
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 B. REPOINTING CRACKS IN EXISTING STONE WALLS SHALL BE REPOINTED WITH MASONRY MORTAR AS SPECIFIED IN SPECIFICATIONS SECTION 040342 HISTORIC STONE MASONRY REPAIR AND REPOINTING.
 C. NEWLY BONDED STONE PIECES/SECTIONS - EXISTING STONE PIECES THAT ARE BROKEN
- AND/OR SEPARATED FROM THE EXISTING STONE WALL OR SECTIONS OF WALL THAT ARE BROKEN SHALL BE REBONDED WITH ALIGNED STONE WALL SECTIONS WITH MASONRY MORTAR AS SPECIFIED IN SPECIFICATIONS SECTION 040342 HISTORIC STONE MASONRY REPAIR AND REPOINTING.
 D. CEMENTATIOUS CAP REPAIRS TO ANY EXISTING CEMENTATIOUS CAP ON EXISTING
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 (11) EXISTING CONCRETE AND OR MASONRY STAIRS NOT INDICATED TO BE PORTIONS OF HISTORICAL CONSTRUCTION TO BE REMOVED IN ENTIRETY AND REPLACED WITH NEW CAST-IN-PLACE CONCRETE STAIRS. REFER TO LANDSCAPE DRAWINGS FOR EXACT LOCATIONS OF PORTIONS OF STAIRS TO REMAIN.

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ACCIDENTAL DAMAGE - CONTACT THE OWNER AND DESIGN TEAM IN THE EVENT OF DAMAGE TO THE EXISTING WALLS OR ADJACENT SITE FEATURES THAT RESULT IN WALLS SECTIONS

NOTES AND REFERENCES:

DAMAGE TO WALL AND ADJACENT FEATURES AND COORDINATE WITH REQUIRED PARTIES PRIOFTO ATTEMPTING REPAIRS.FOR ALL WORK RELATED TO THE REMOVAL, DISMANTLING, CLEANING, REPAIR AND TREATMENTOF EXISTING STRUCTURES REFER TO THE FOLLOWING SPECIFICATIONS FOR ALL ALLOWABLEMETHODS AND MATERIALS:GENERAL HISTORIC TREATMENT PROCEDURES: SPECIFICATIONS SECTION 013591 HISTORIC

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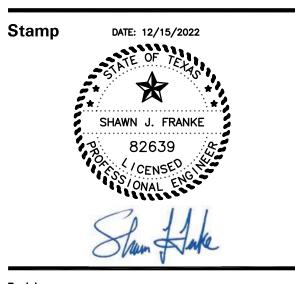
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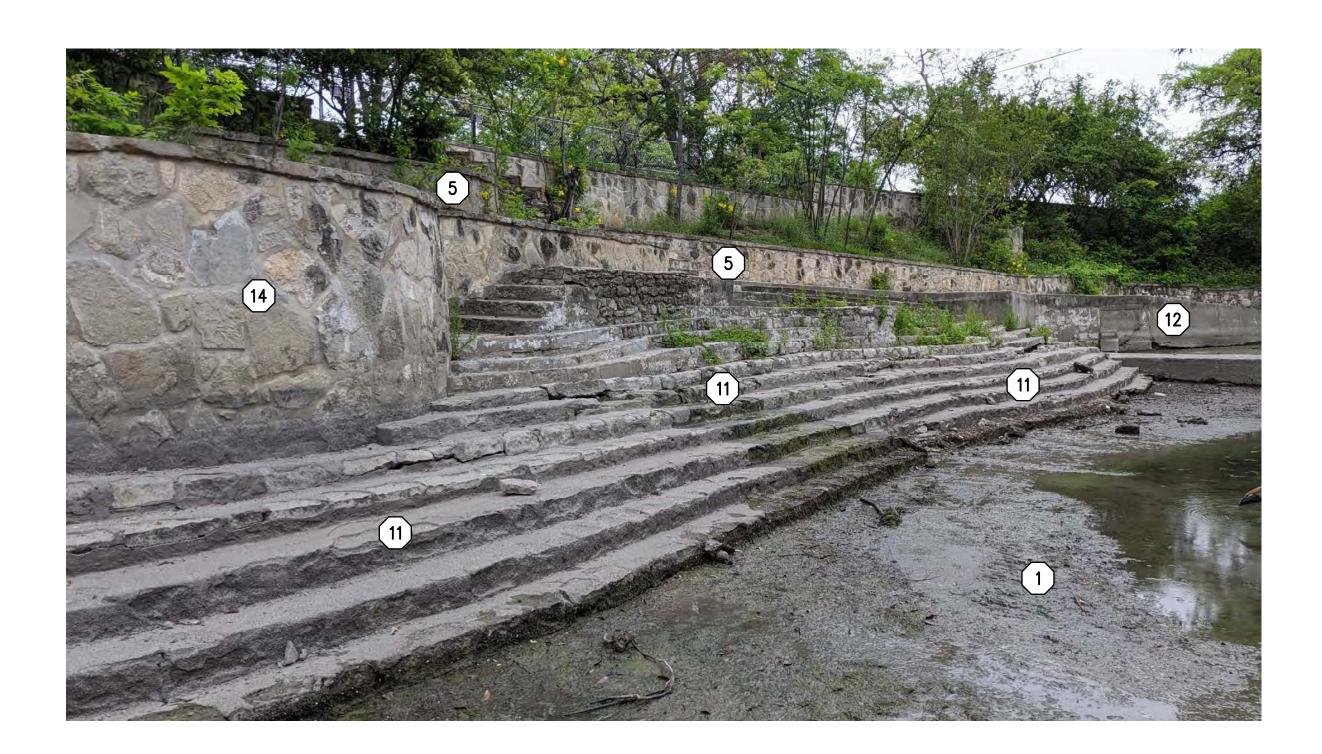
Revisions

Date 11 JANUARY 2023 Phase 95% CONSTRUCTION DOCUMENTS Job Number CNOS701 Scale North COS701 Scale North COS701 Drawing Title PHOTO SURVEY & KEYNOTES Drawing Number S4.01


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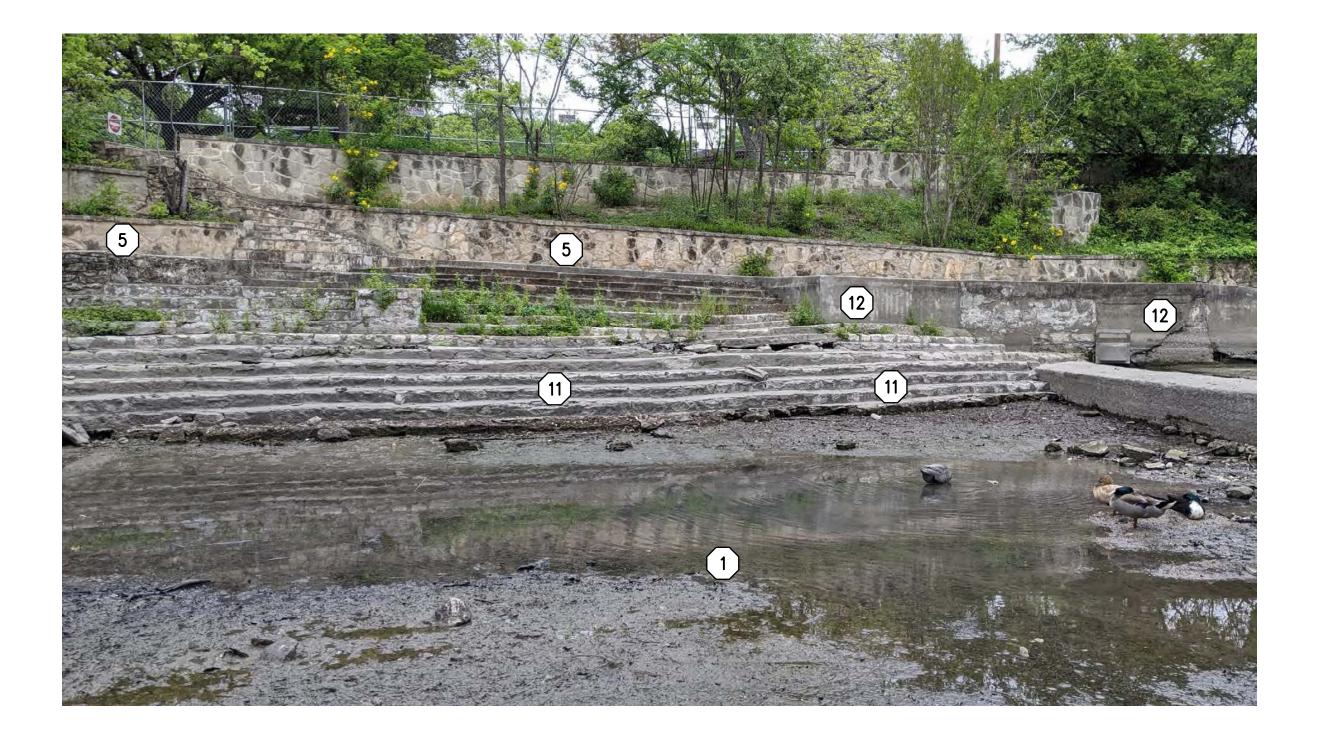






TYPICAL N.T.S.

2 PHOTO

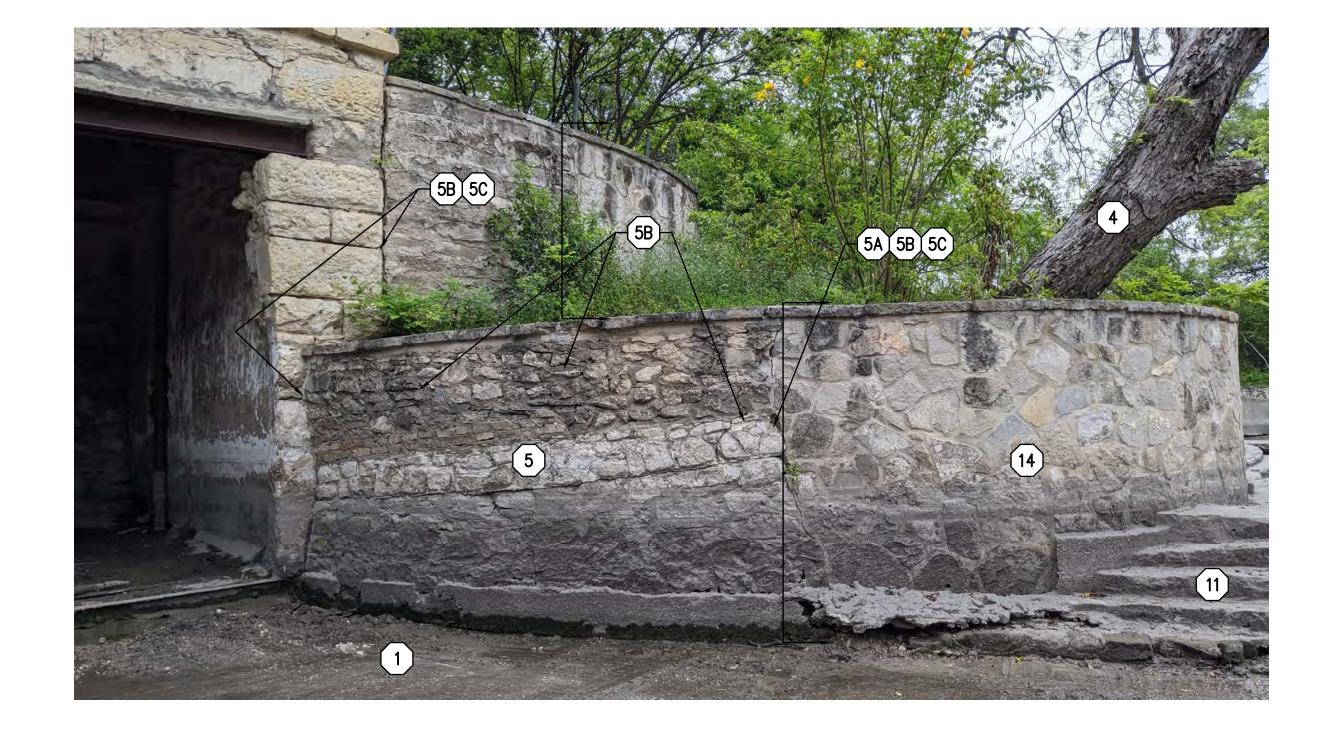



TYPICAL N.T.S.


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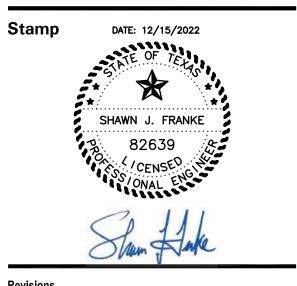
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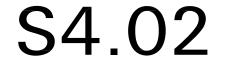
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Date 11 JANUARY 2023 Phase 95% CONSTRUCTION DOCUMENTS Job Number CNOS701 Drawing Title **PHOTO SURVEY & KEYNOTES** Drawing Number






T PHOTO



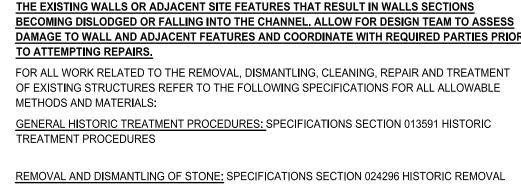

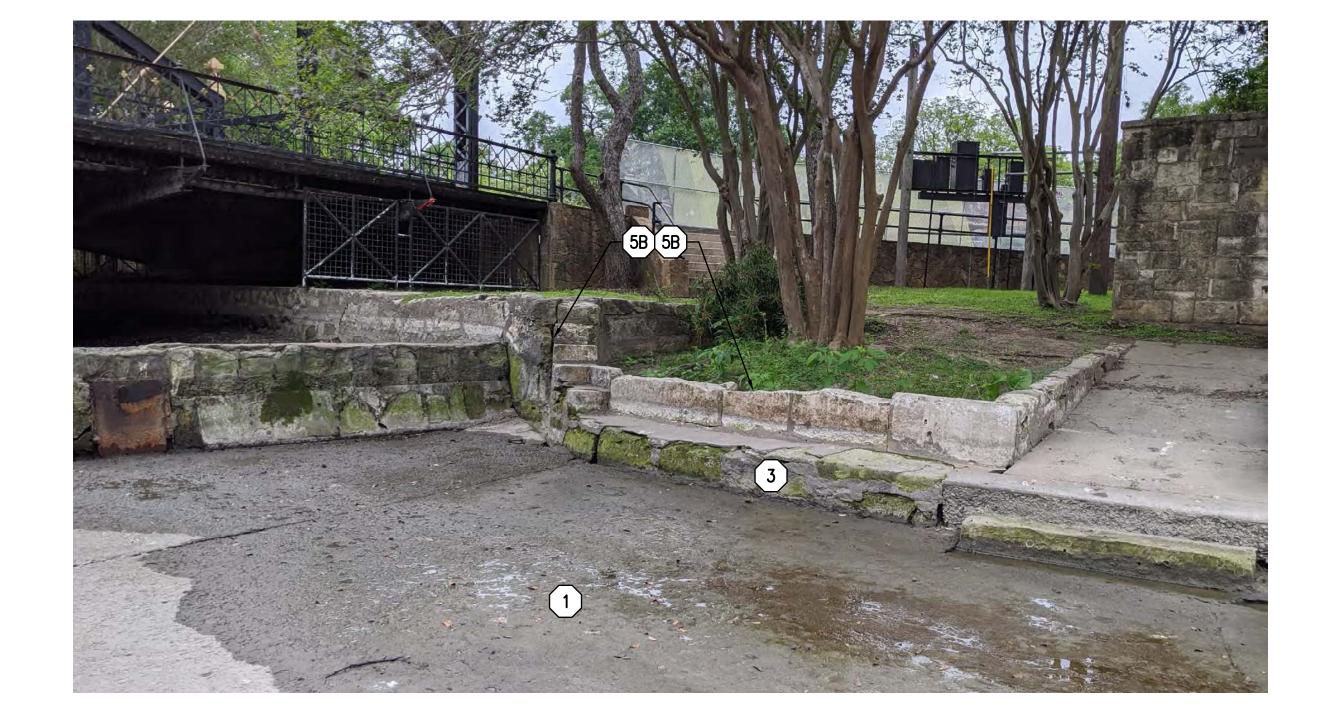

TYPICAL N.T.S.

2 PHOTO







TYPICAL N.T.S.

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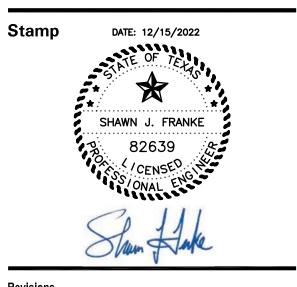
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INTELLIGENT ENGINEERING SERVICE CIVIL ENGINEER 1045 CENTRAL PARKWAY NORTH, SUITE 200, SAN ANTONIO, TX 78232

TRUE NORTH CONSULTING GROUP IT AND COMMUNICATIONS 13284 POND SPRINGS ROAD, STE. 304 AUSTIN TX, 78729

CNG ENGINEERING MEP 1917 N. NEW BRAUNFELS AVE., SUITE 201, SAN ANTONIO TX, 78208


WGI ENGINEERING HYDROLOGY 5710 W HAUSMAN RD. SAN ANTONIO, TX 78249



Date 11 JANUARY 2023 Phase 95% CONSTRUCTION DOCUMENTS Job Number CNOS701 Drawing Title **PHOTO SURVEY & KEYNOTES** Drawing Number

S4.03



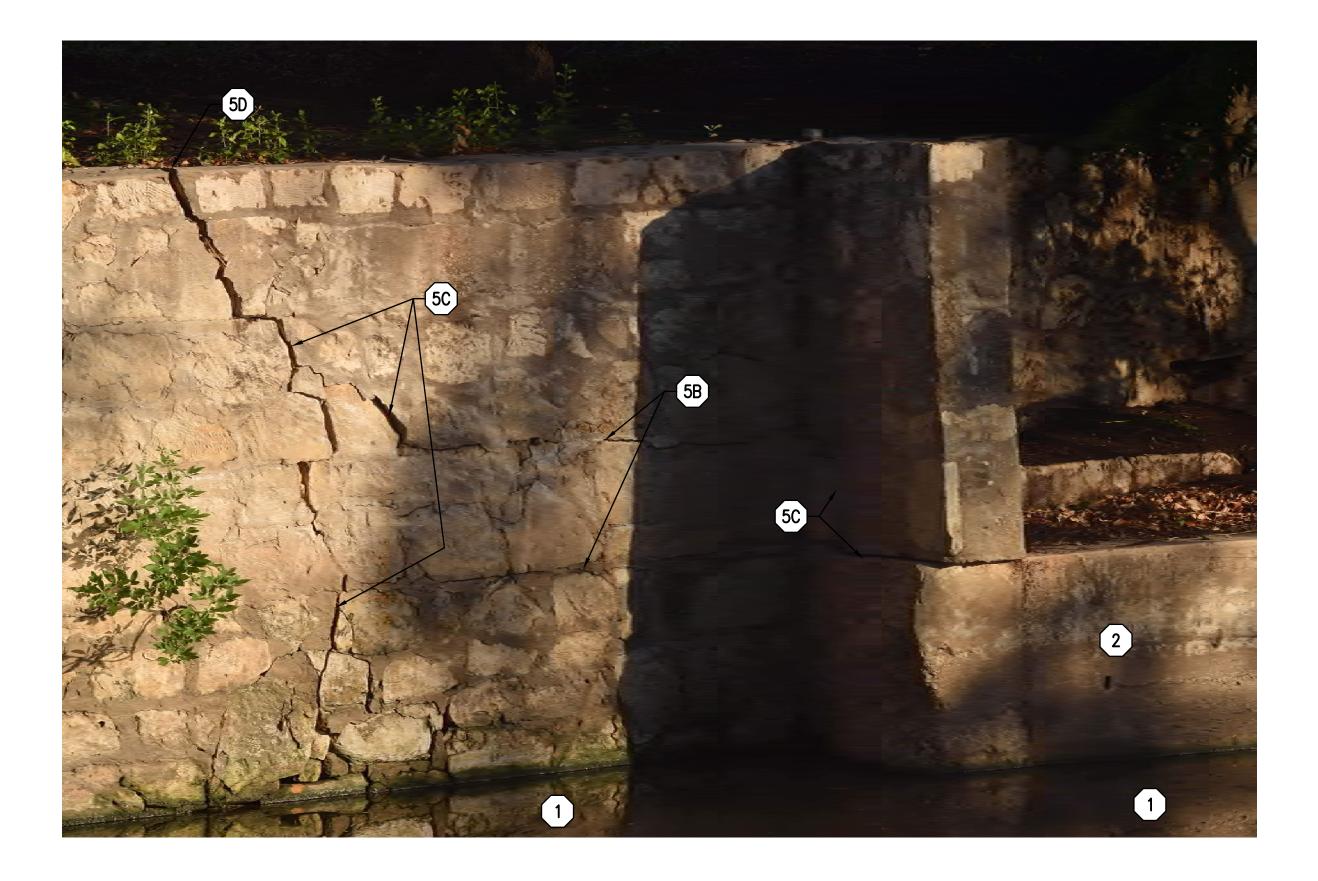


(1) PHOTO




LA PROJECT NO.: 03-257-00 LA FILE NO.: BRWBRS4-04

(3) PHOTO

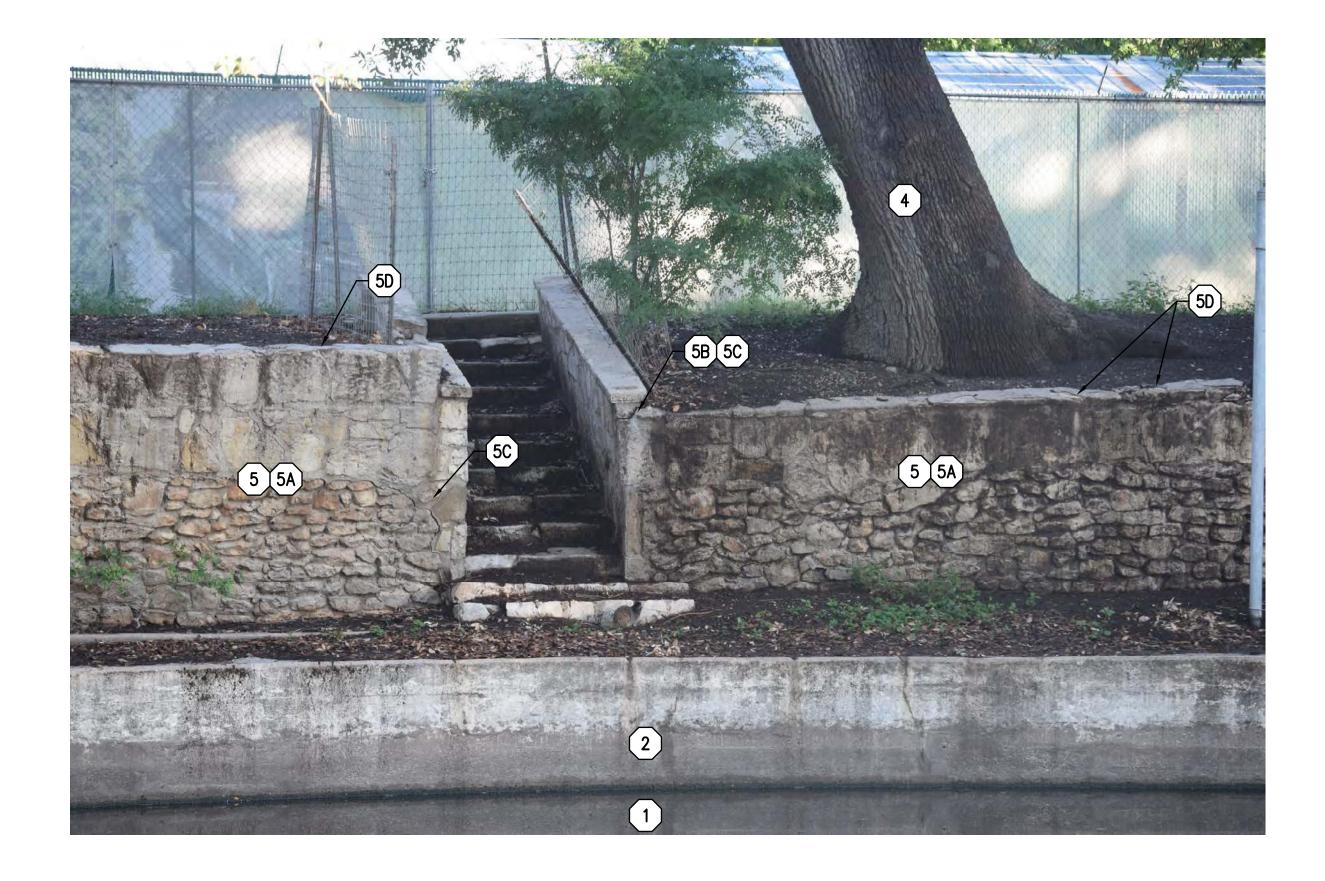

TYPICAL N.T.S. 2 PHOTO

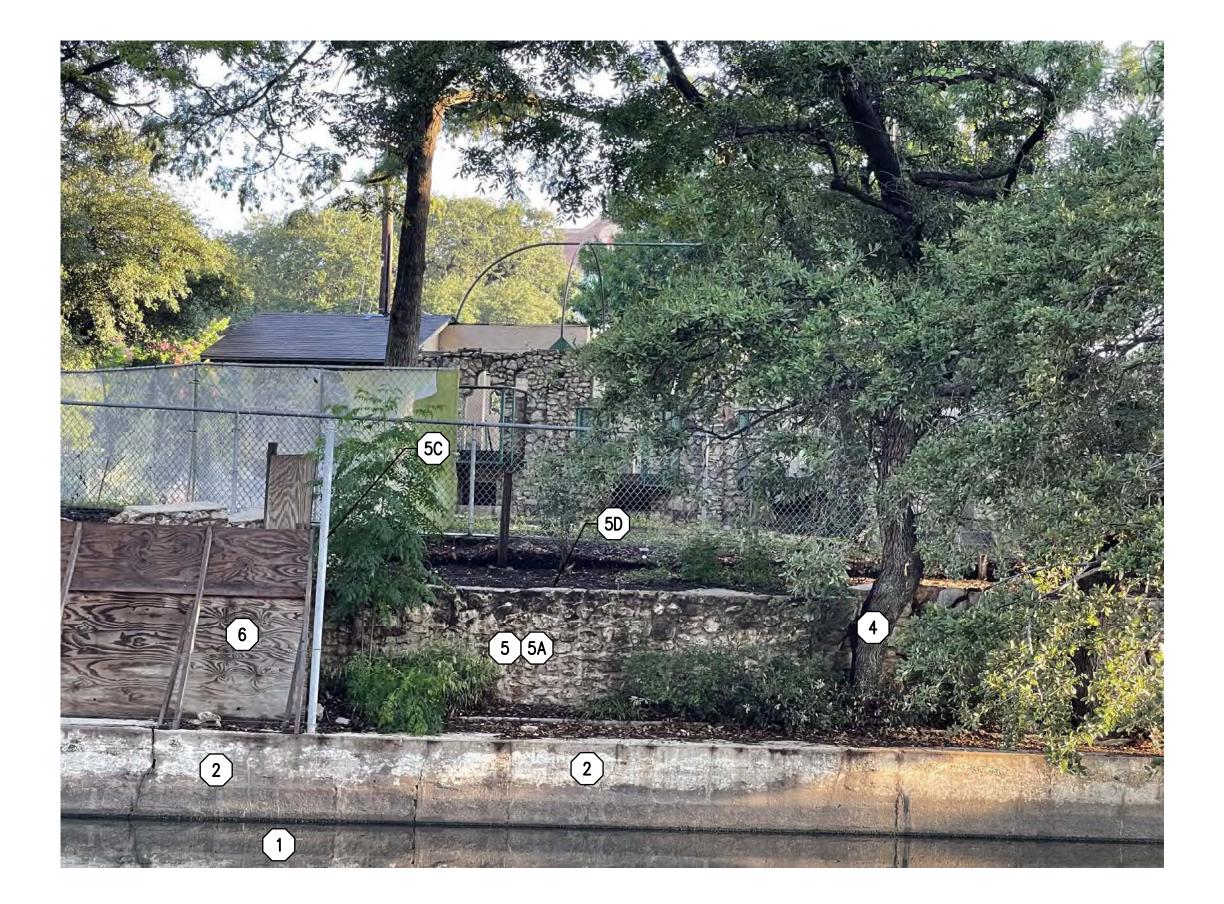

 4

TYPICAL N.T.S. (1) EXISTING CHANNEL BOTTOM TO REMAIN. EXISTING CHANNEL BOTTOM TO BE REPAIRED AS NECESSARY DURING CONSTRUCTION BASED ON SITE CONDITIONS EXPOSED DURING DEWATERING. ALL ORGANIC AND DELETERIOUS MATERIAL TO BE REMOVED FROM THE CHANNEL AFTER DEWATERING TO ALLOW FOR FULL ASSESSMENT OF THE EXISTING CONCRETE CHANNEL. PRECAUTIONS TO BE TAKEN DURING CONSTRUCTION TO PREVENT FURTHER DAMAGE TO THE EXISTING CHANNEL. CONTRACTOR RESPONSIBLE FOR ALL DAMAGE BEYOND EXISTING DAMAGE, CAUSED BY CONSTRUCTION ACCESS.
 (2) EXISTING CONCRETE CHANNEL WALL TO REMAIN.
 (3) EXISTING CONCRETE WALKWAY SLAB TO BE REMOVED AND REPLACED WITH NEW

- CONCRETE SLAB. EXISTING CHANNEL WALL TO BE BACKED WITH SHADOW WALL BELOW NEW WALKWAY SLAB PER STRUCTURAL DETAILS.
 TREE/VEGETATION TO BE REMOVED. ALL TREE/VEGETATION REMOVAL TO BE COMPLETED ACCORDING TO LANDSCAPING/TREE REMOVAL AND MITIGATION DRAWINGS.
 EXISTING STONE RETAINING WALL TO REMAIN AND BE ANCHORED TO AND SUPPORTED BY A NEW CAST-IN-PLACE CONCRETE "SHADOW" WALL BEHIND THE EXISTING STONE WALL. ALL
- STONE WALLS TO BE ANCHORED TO NEW "SHADOW WALL BY MEANS DEPECTIED IN DETAILS WITHIN THIS SET OF DRAWINGS.
 A. REALIGN EXISTING RETAINING WALL TO REMAIN AND BE REALIGNED TO A MORE VERTICAL POSITION. FIELD VERIFY VERITCAL ALIGNMENT. WALLS SECTIONS FIELD VERIFIED TO BE LEANING OUTWARD TOWARDS THE CHANNEL/RIVER SHALL BE ATTEMPTED TO BE REALIGNED TO A MORE VERTICAL POSITION. ALL ATTEMPTS TO REALIGN WALLS VERTICALLY SHALL BE LIMITED TO NON-DESTRUCTIVE METHODS.
- B. REPOINTING CRACKS IN EXISTING STONE WALLS SHALL BE REPOINTED WITH MASONRY MORTAR AS SPECIFIED IN SPECIFICATIONS SECTION 040342 HISTORIC STONE MASONRY REPAIR AND REPOINTING.
 C. NEWLY BONDED STONE PIECES/SECTIONS - EXISTING STONE PIECES THAT ARE BROKEN AND/OR SEPARATED FROM THE EXISTING STONE WALL OR SECTIONS OF WALL THAT ARE
- BROKEN SHALL BE REBONDED WITH ALIGNED STONE WALL SECTIONS WITH MASONRY MORTAR AS SPECIFIED IN SPECIFICATIONS SECTION 040342 HISTORIC STONE MASONRY REPAIR AND REPOINTING.
- D. CEMENTATIOUS CAP REPAIRS TO ANY EXISTING CEMENTATIOUS CAP ON EXISTING STONE WALLS SHALL BE REPAIRED OR RECONSTRUCTED WITH MASONRY MORTAR AS SPECIFIED IN SPECIFICATIONS SECTION 040342 HISTORIC STONE MASONRY REPAIR AND REPOINTING.
 E. TOP OF EXISTING WALL - DO NOT ADD TO THE HEIGHT OF THE EXISTING WALL.
- REALIGNMENT OF THE WALL INTO A MORE VERTICAL POSITION IS NOT CONSIDERED ALTERING THE HEIGHT OF THE EXISTING WALL.
 MEW STONE WALL TO BE CONSTRUCTED UTILIZING RECLAIMED/SALVAGED STONE AND NEW STONE USING HISTORICAL CONSTRUCTION ALLOWABLE METHODS OUTLINED WITHIN SPECIFICATIONS. NEW STONE WALL TO BE BACKED AND ANCHORED TO NEW CAST-IN-PLACE CONCRETE "SHADOW" WALL SHOWN IN DETAILS WITHIN THIS STRUCTURAL SET. OWNER WILL
- PROVIDE MAJORITY OF SALVAGED STONE. CONTRACTOR MAY HAVE TO SUPPLEMENT WITH SAME TO FULLY CONSTRUCT. FAILED EXISTING CONCRETE CHANNEL WALL TO BE REMOVED AND REPLACED WITH NEW CONCRETE PER DETAILS WITHIN THIS STRUCTURAL SET. MULTI-PLANAR FAILURE OF CONCRETE CAUSED BY EXPOSURE TO SCOURING FORCES OF RIVER.
- 8. EXISTING FALLEN STONE WALL SECTION TO BE RECLAIMED AND LIFTED BACK INTO ALIGNMENT WITH EXISTING STONE WALL. NEW CAST-IN-PLACE CONCRETE WALL TO BE PLACED BEHIND EXISTING STONE WALL FOR SUPPORT AND ANCHORAGE.
- (9) EXISTING PUMP HOUSE FOUNDATION TO BE REMOVED AND REPLACED WITH CONCRETE UNDERPINNING AS DETAILED ON \$2.01. EXISTING STRUCTURE TO BE SHORED PRIOR TO COMMENCMENT OF UNDERPINNING.
 (10) EXISTING PUMP HOUSE. NO STRUCTURAL WORK ABOVE FOUNDATION TO BE COMPLETED
- IN THIS PHASE. TEMPORARY SHORING DURING FOUNDATION UNDERPINNING TO BE IN PLACE PRIOR TO COMMENCEMENT OF CONSTRUCTION. IN EXISTING CONCRETE AND OR MASONRY STAIRS NOT INDICATED TO BE PORTIONS OF HISTORICAL CONSTRUCTION TO BE REMOVED IN ENTIRETY AND REPLACED WITH NEW CAST-IN-PLACE CONCRETE STAIRS. REFER TO LANDSCAPE DRAWINGS FOR EXACT

LOCATIONS OF PORTIONS OF STAIRS TO REMAIN. (2) EXISTING CONCRETE RAMPS TO REMAIN IN PLACE.

13 NOT IN SCOPE
 14 EXISTING STONE WALL TO BE DEMOLISHED AT JOINT OF ORIGINAL WALL & NEWER WALL & BE REBUILT WITH CONCRETE SHADOW WALL

* ITEMS LABELED AS NOTE 5 OR 5 SUBNOTE MAY HAVE MORE THAN ONE APPLICABLE SUBNOTE BASED ON CONDITIONS ENCOUNTERED AT TIME OF CONSTRUCTION

ACCIDENTAL DAMAGE - CONTACT THE OWNER AND DESIGN TEAM IN THE EVENT OF DAMAGE TO THE EXISTING WALLS OR ADJACENT SITE FEATURES THAT RESULT IN WALLS SECTIONS

NOTES AND REFERENCES:

 DAMAGE TO WALL AND ADJACENT FEATURES AND COORDINATE WITH REQUIRED PARTIES PRIOF

 TO ATTEMPTING REPAIRS.

 FOR ALL WORK RELATED TO THE REMOVAL, DISMANTLING, CLEANING, REPAIR AND TREATMENT

 OF EXISTING STRUCTURES REFER TO THE FOLLOWING SPECIFICATIONS FOR ALL ALLOWABLE

 METHODS AND MATERIALS:

 GENERAL HISTORIC TREATMENT PROCEDURES: SPECIFICATIONS SECTION 013591 HISTORIC

 TREATMENT PROCEDURES: SPECIFICATIONS SECTION 013591 HISTORIC

BECOMING DISLODGED OR FALLING INTO THE CHANNEL. ALLOW FOR DESIGN TEAM TO ASSESS

REMOVAL AND DISMANTLING OF STONE: SPECIFICATIONS SECTION 024296 HISTORIC REMOVAL AND DISMANTLING

CLEANING OF STONE: SPECIFICATIONS SECTION 040310 HISTORIC STONE MASONRY CLEANING

REPAIR OF STONE: SPECIFICATIONS SECTION 040342 HISTORIC STONE MASONRY REPAIR AND REPOINTING & 040515 PREPARING LIME MORTAR FOR HISTORIC MASONRY

TYPICAL N.T.S.

BRACKENRIDGE Park

SAN ANTONIO, TX

CLIENT:

CITY OF SAN ANTONIO PUBLIC WORKS DEPARTMENT (TCI) PO BOX 839966, SAN ANTONIO TX 78283-3966

LANDSCAPE ARCHITECT



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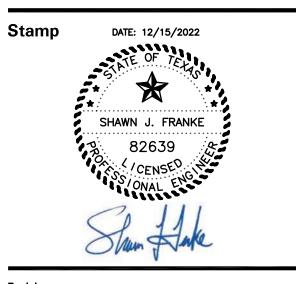
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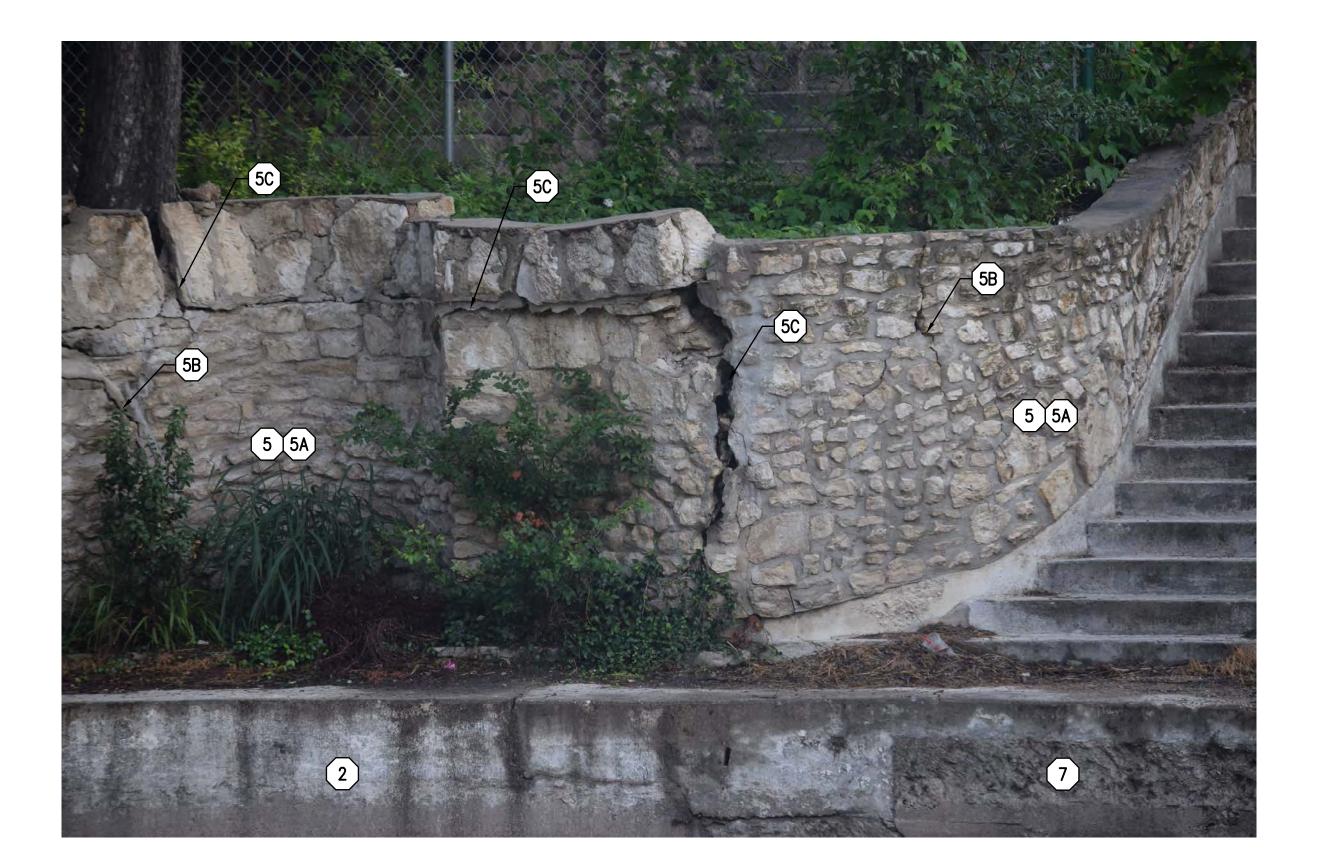
WGI ENGINEERING HYDROLOGY 5710 W HAUSMAN RD. SAN ANTONIO, TX 78249

SAN ANTONIO TX, 78208




Date 11 JANUARY 2023 Phase 95% CONSTRUCTION DO Job Number CNOS701	OCUMENTS
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LA PROJECT NO.: 03-257-00 LA FILE NO.: BRWBRS4-05





TYPICAL N.T.S.

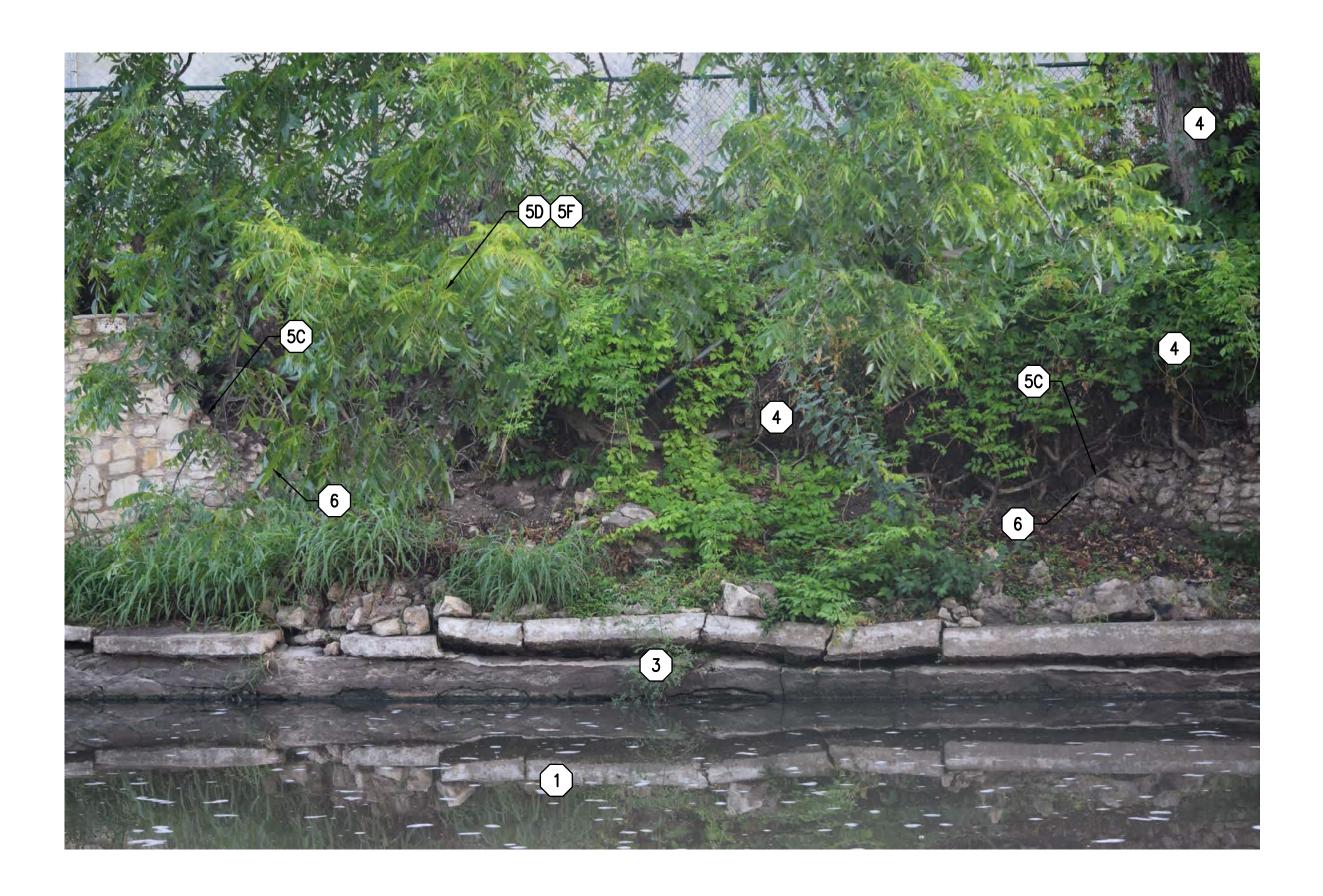2 PHOTO



TYPICAL N.T.S.

4 PHOTO

TYPICAL N.T.S.

TYPICAL N.T.S.

(1.) EXISTING CHANNEL BOTTOM TO REMAIN. EXISTING CHANNEL BOTTOM TO BE REPAIRED AS
NECESSARY DURING CONSTRUCTION BASED ON SITE CONDITIONS EXPOSED DURING
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_ WALKWAY SLAB PER STRUCTURAL DETAILS.
(4.)TREE/VEGETATION TO BE REMOVED. ALL TREE/VEGETATION REMOVAL TO BE COMPLETED
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- *(5) EXISTING STONE RETAINING WALL TO REMAIN AND BE ANCHORED TO AND SUPPORTED BY A NEW CAST-IN-PLACE CONCRETE "SHADOW" WALL BEHIND THE EXISTING STONE WALL. ALL STONE WALLS TO BE ANCHORED TO NEW "SHADOW WALL BY MEANS DEPECTIED IN DETAILS WITHIN THIS SET OF DRAWINGS.
 A. REALIGN - EXISTING RETAINING WALL TO REMAIN AND BE REALIGNED TO A MORE VERTICAL POSITION. FIELD VERIFY VERITCAL ALIGNMENT. WALLS SECTIONS FIELD VERIFIED TO BE LEANING OUTWARD TOWARDS THE CHANNEL/RIVER SHALL BE ATTEMPTED TO BE REALIGNED TO A MORE VERTICAL POSITION. ALL ATTEMPTS TO REALIGN WALLS VERTICALLY SHALL BE LIMITED TO NON-DESTRUCTIVE METHODS.
 B. REPOINTING - CRACKS IN EXISTING STONE WALLS SHALL BE REPOINTED WITH MASONRY
- MORTAR AS SPECIFIED IN SPECIFICATIONS SECTION 040342 HISTORIC STONE MASONRY REPAIR AND REPOINTING. C. NEWLY BONDED STONE PIECES/SECTIONS - EXISTING STONE PIECES THAT ARE BROKEN AND/OR SEPARATED FROM THE EXISTING STONE WALL OR SECTIONS OF WALL THAT ARE BROKEN SHALL BE REBONDED WITH ALIGNED STONE WALL SECTIONS WITH MASONRY
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 (6.) NEW STONE WALL TO BE CONSTRUCTED UTILIZING RECLAIMED/SALVAGED STONE AND NEW STONE USING HISTORICAL CONSTRUCTION ALLOWABLE METHODS OUTLINED WITHIN SPECIFICATIONS. NEW STONE WALL TO BE BACKED AND ANCHORED TO NEW CAST-IN-PLACE CONCRETE "SHADOW" WALL SHOWN IN DETAILS WITHIN THIS STRUCTURAL SET. OWNER WILL
- PROVIDE MAJORITY OF SALVAGED STONE. CONTRACTOR MAY HAVE TO SUPPLEMENT WITH SAME TO FULLY CONSTRUCT.
 (7) FAILED EXISTING CONCRETE CHANNEL WALL TO BE REMOVED AND REPLACED WITH NEW CONCRETE PER DETAILS WITHIN THIS STRUCTURAL SET. MULTI-PLANAR FAILURE OF CONCRETE CAUSED BY EXPOSURE TO SCOURING FORCES OF RIVER.
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- EXISTING CONCRETE AND OR MASONRY STAIRS NOT INDICATED TO BE PORTIONS OF HISTORICAL CONSTRUCTION TO BE REMOVED IN ENTIRETY AND REPLACED WITH NEW CAST-IN-PLACE CONCRETE STAIRS. REFER TO LANDSCAPE DRAWINGS FOR EXACT LOCATIONS OF PORTIONS OF STAIRS TO REMAIN.
 EXISTING CONCRETE RAMPS TO REMAIN IN PLACE.

13 NOT IN SCOPE

- (4) EXISTING STONE WALL TO BE DEMOLISHED AT JOINT OF ORIGINAL WALL & NEWER WALL & BE REBUILT WITH CONCRETE SHADOW WALL
- * ITEMS LABELED AS NOTE 5 OR 5 SUBNOTE MAY HAVE MORE THAN ONE APPLICABLE SUBNOTE BASED ON CONDITIONS ENCOUNTERED AT TIME OF CONSTRUCTION

NOTES AND REFERENCES: ACCIDENTAL DAMAGE - CONTACT THE OWNER AND DESIGN TEAM IN THE EVENT OF DAMAGE TO THE EXISTING WALLS OR ADJACENT SITE FEATURES THAT RESULT IN WALLS SECTIONS

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LANDSCAPE ARCHITECT



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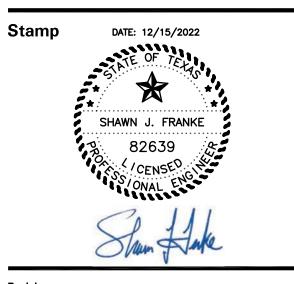
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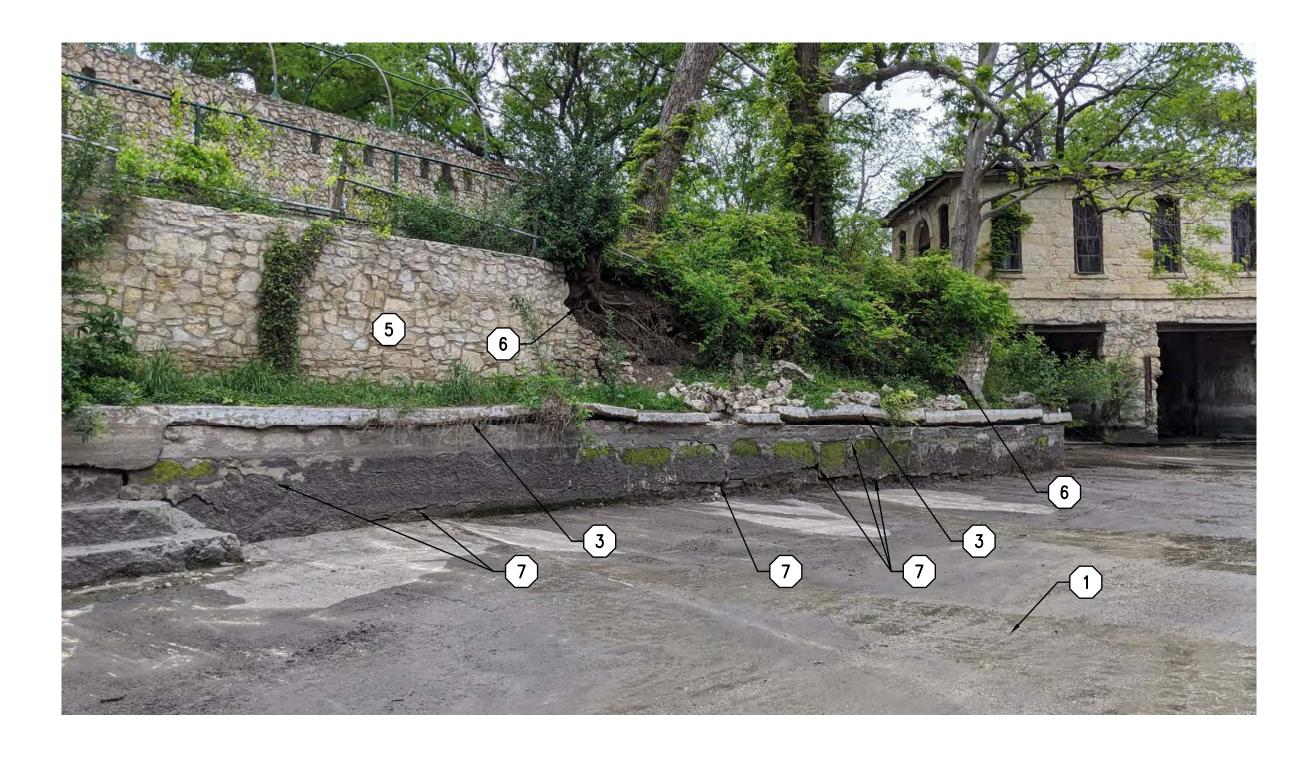
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Revisions


Date 11 JANUARY 2023 Phase 95% CONSTRUCTION DOCUMENTS Job Number CNOS701 Scale North COS701 Scale North COS701 Drawing Title PHOTO SURVEY & KEYNOTES Drawing Number S4.055

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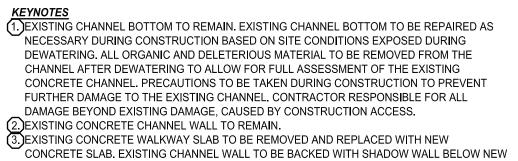
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TYPICAL N.T.S.

2 PHOTO

TYPICAL N.T.S.

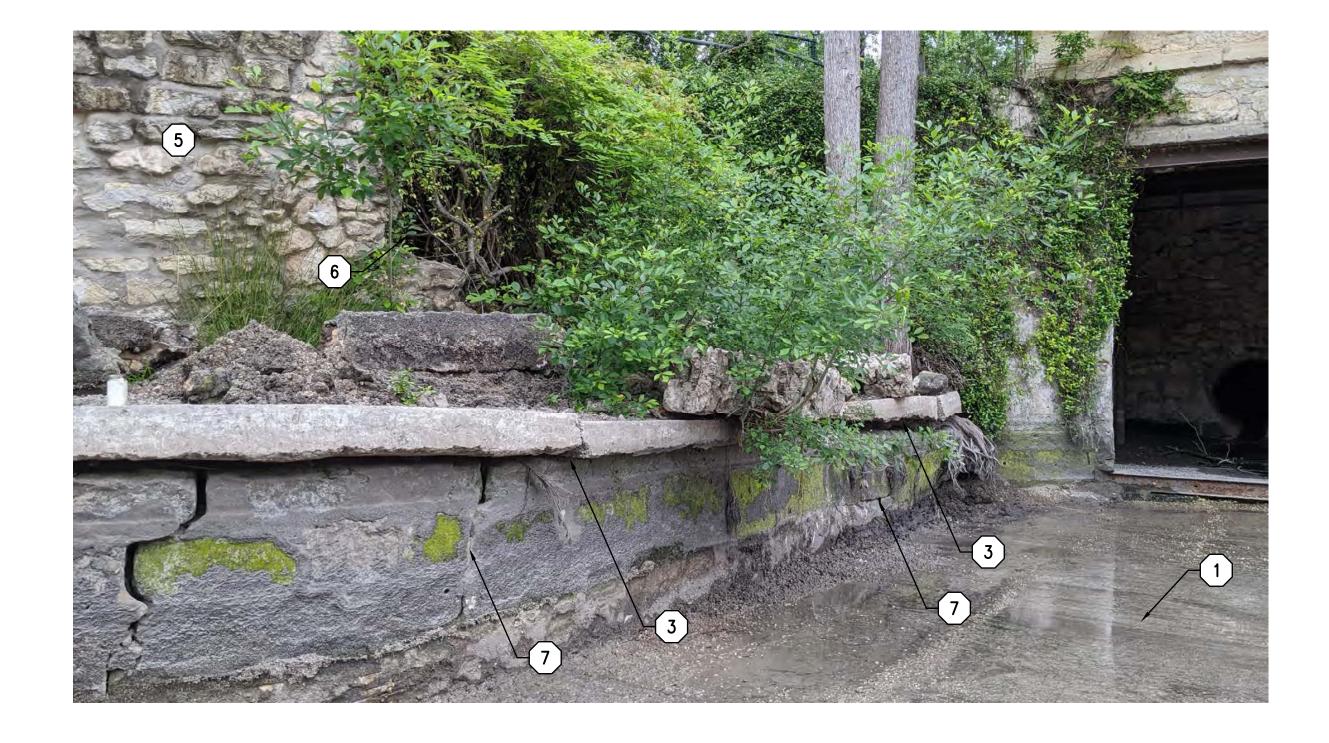

- WALKWAY SLAB PER STRUCTURAL DETAILS. (4.) TREE/VEGETATION TO BE REMOVED. ALL TREE/VEGETATION REMOVAL TO BE COMPLETED ACCORDING TO LANDSCAPING/TREE REMOVAL AND MITIGATION DRAWINGS. *(5.) EXISTING STONE RETAINING WALL TO REMAIN AND BE ANCHORED TO AND SUPPORTED BY A NEW CAST-IN-PLACE CONCRETE "SHADOW" WALL BEHIND THE EXISTING STONE WALL. ALL STONE WALLS TO BE ANCHORED TO NEW "SHADOW WALL BY MEANS DEPECTIED IN DETAILS WITHIN THIS SET OF DRAWINGS. A. REALIGN - EXISTING RETAINING WALL TO REMAIN AND BE REALIGNED TO A MORE VERTICAL POSITION. FIELD VERIFY VERITCAL ALIGNMENT. WALLS SECTIONS FIELD
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- C. NEWLY BONDED STONE PIECES/SECTIONS EXISTING STONE PIECES THAT ARE BROKEN AND/OR SEPARATED FROM THE EXISTING STONE WALL OR SECTIONS OF WALL THAT ARE BROKEN SHALL BE REBONDED WITH ALIGNED STONE WALL SECTIONS WITH MASONRY MORTAR AS SPECIFIED IN SPECIFICATIONS SECTION 040342 HISTORIC STONE MASONRY REPAIR AND REPOINTING.
- D. CEMENTATIOUS CAP REPAIRS TO ANY EXISTING CEMENTATIOUS CAP ON EXISTING STONE WALLS SHALL BE REPAIRED OR RECONSTRUCTED WITH MASONRY MORTAR AS SPECIFIED IN SPECIFICATIONS SECTION 040342 HISTORIC STONE MASONRY REPAIR AND REPOINTING. E. TOP OF EXISTING WALL - DO NOT ADD TO THE HEIGHT OF THE EXISTING WALL. REALIGNMENT OF THE WALL INTO A MORE VERTICAL POSITION IS NOT CONSIDERED
- ALTERING THE HEIGHT OF THE EXISTING WALL. 6. NEW STONE WALL TO BE CONSTRUCTED UTILIZING RECLAIMED/SALVAGED STONE AND NEW STONE USING HISTORICAL CONSTRUCTION ALLOWABLE METHODS OUTLINED WITHIN SPECIFICATIONS. NEW STONE WALL TO BE BACKED AND ANCHORED TO NEW CAST-IN-PLACE CONCRETE "SHADOW" WALL SHOWN IN DETAILS WITHIN THIS STRUCTURAL SET. OWNER WILL PROVIDE MAJORITY OF SALVAGED STONE. CONTRACTOR MAY HAVE TO SUPPLEMENT WITH
- SAME TO FULLY CONSTRUCT. 7. FAILED EXISTING CONCRETE CHANNEL WALL TO BE REMOVED AND REPLACED WITH NEW CONCRETE PER DETAILS WITHIN THIS STRUCTURAL SET. MULTI-PLANAR FAILURE OF CONCRETE CAUSED BY EXPOSURE TO SCOURING FORCES OF RIVER. (8.) EXISTING FALLEN STONE WALL SECTION TO BE RECLAIMED AND LIFTED BACK INTO ALIGNMENT WITH EXISTING STONE WALL. NEW CAST-IN-PLACE CONCRETE WALL TO BE
- PLACED BEHIND EXISTING STONE WALL FOR SUPPORT AND ANCHORAGE. (9.) EXISTING PUMP HOUSE FOUNDATION TO BE REMOVED AND REPLACED WITH CONCRETE UNDERPINNING AS DETAILED ON S2.01. EXISTING STRUCTURE TO BE SHORED PRIOR TO COMMENCMENT OF UNDERPINNING. (10) EXISTING PUMP HOUSE. NO STRUCTURAL WORK ABOVE FOUNDATION TO BE COMPLETED
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(12) EXISTING CONCRETE RAMPS TO REMAIN IN PLACE. 13 NOT IN SCOPE

(4) EXISTING STONE WALL TO BE DEMOLISHED AT JOINT OF ORIGINAL WALL & NEWER WALL & BE REBUILT WITH CONCRETE SHADOW WALL

* ITEMS LABELED AS NOTE 5 OR 5 SUBNOTE MAY HAVE MORE THAN ONE APPLICABLE SUBNOTE BASED ON CONDITIONS ENCOUNTERED AT TIME OF CONSTRUCTION

ACCIDENTAL DAMAGE - CONTACT THE OWNER AND DESIGN TEAM IN THE EVENT OF DAMAGE TO THE EXISTING WALLS OR ADJACENT SITE FEATURES THAT RESULT IN WALLS SECTIONS

NOTES AND REFERENCES:

DAMAGE TO WALL AND ADJACENT FEATURES AND COORDINATE WITH REQUIRED PARTIES PRIOR TO ATTEMPTING REPAIRS. FOR ALL WORK RELATED TO THE REMOVAL, DISMANTLING, CLEANING, REPAIR AND TREATMENT OF EXISTING STRUCTURES REFER TO THE FOLLOWING SPECIFICATIONS FOR ALL ALLOWABLE METHODS AND MATERIALS: GENERAL HISTORIC TREATMENT PROCEDURES: SPECIFICATIONS SECTION 013591 HISTORIC TREATMENT PROCEDURES

BECOMING DISLODGED OR FALLING INTO THE CHANNEL. ALLOW FOR DESIGN TEAM TO ASSESS

REMOVAL AND DISMANTLING OF STONE: SPECIFICATIONS SECTION 024296 HISTORIC REMOVAL AND DISMANTLING

CLEANING OF STONE: SPECIFICATIONS SECTION 040310 HISTORIC STONE MASONRY CLEANING

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BRACKENRIDGE PARK

SAN ANTONIO, TX

CLIENT:

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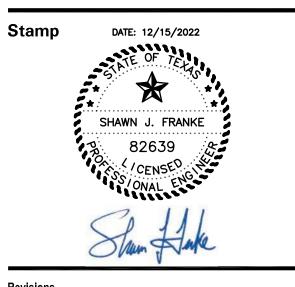
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Date 11 JANUARY 2023 Phase 95% CONSTRUCTION D Job Number CNOS701	OCUMENTS
Scale	North
Drawing Title PHOTO SURV	EY & KEYNOTES
Drawing Number	
S4	.06